

CITY OF WATERTOWN, MASSACHUSETTS

FILIPPELLO PARK

SPRAY PAD RENOVATION



LOCATION PLAN
NTS

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FEBRUARY 2023



**CDM
Smith**

BOSTON, MASSACHUSETTS

Water

Environment

Transportation

Energy

Facilities

SURVEY LEGEND:

	SURVEY CONTROL STATION		SIGN
	IRON PIPE		BORING
	CONCRETE BOUND W/LEAD PLUG		UTILITY POLE
	STONE BOUND		UTILITY POLE/LIGHT POLE
	FOUND		LIGHT POLE
	PARKER KALON CONCRETE NAIL		UTILITY POLE
	FERROUS SPIKE		GUY POLE
	FERROUS NAIL		SANITARY SEWER MANHOLE
	TREELINE		HANDHOLE
	DECIDUOUS TREE		MANHOLE
	EVERGREEN TREE		DRAIN MANHOLE
	BOULDER		CATCH BASIN
	SHRUB OR BUSH		RIM
	FENCE		INVERT
	CHAIN LINK FENCE		TOP OF WATER
	WOOD FENCE TYPES		TOP OF ELBOW
	POST & RAIL FENCE		TOP OF HOOD
	STOCKADE		TOP OF SILT
	WROUGHT IRON FENCE		TOP OF WATER
	CONCRETE RETAINING WALL		GAS GATE
	RETAINING WALL		WATER GATE
	CURBING(TYPE)		HYDRANT
	BITUMINOUS CONCRETE		METAL POST
	GRASS		IRRIGATION CONTROL VALVE
	LIGHT POLE WITH BASE		TRANSFORMER
	PLANTER		FIRE ALARM BOX
	CONCRETE CURB		SANITARY SEWER LINE
	GRANITE CURB		OVERHEAD WIRE
	BITUMINOUS CONCRETE CURB		WATER LINE
	BITUMINOUS CONCRETE PATCH		CABLE TELEVISION LINE
	BITUMINOUS CONCRETE DRIVE		GAS LINE
	CONCRETE WALK		ELECTRIC LINE
	CONCRETE		DRAINAGE LINE
	BRICK		MARKED
	LANDSCAPE TIMBER		CAST IRON PIPE
	MASONRY		PLASTIC PIPE
	CONCRETE RETAINING WALL		BAR STEEL
	FLAG STONE WALK		NO PIPES VISIBLE
	BIT CONC SIDEWALK		DUCTILE IRON
	PICKET FENCE		POLY VINYL CHLORIDE
	COBBLE STONE EDGING		REINFORCED CONCRETE PIPE
	METAL POST		VITRIFIED CLAY
	SIGN POST		ASBESTOS CONCRETE
	CONCRETE PAD		WITH
	REINFORCE CONCRETE PIPE		RECORD
	CONCRETE POST		CORRUGATED PLASTIC PIPE
	WATER LEVEL		CONNECTION UNDETERMINED

SURVEY NOTES:

- COORDINATES, IN U.S. SURVEY FEET, ARE REFERENCED TO THE NORTH AMERICAN DATUM OF 1983, (2011), Epoch 2010.00, BASED ON THE KeyNet GPS VIRTUAL REFERENCE SYSTEM (VRS).
- EXISTING CONDITIONS SURVEY WAS COMPLETED ON NOVEMBER 7, 2017 BY SURVEYING AND MAPPING CONSULTANTS AT 1.781.380.7766 325 WOOD ROAD, SUITE 109 BRAINTREE, MA 02184.
- ELEVATIONS, IN U.S. SURVEY FEET, ARE REFERENCED TO THE NORTH AMERICAN VERTICAL DATUM OF 1988 (NAVD88), BASED ON SMC'S OBSERVATIONS OF THE KeyNet GPS VIRTUAL REFERENCE SYSTEM (VRS), USING TRIMBLE R8 GNSS GPS RECEIVERS.
- SUBSURFACE UTILITY LINES, AS SHOWN HEREON, WERE COMPILED ACCORDING TO AVAILABLE RECORD INFORMATION FROM THE REFERENCED COMPANIES AND PUBLIC AGENCIES, AND THEIR LOCATIONS ARE APPROXIMATE ONLY. ACTUAL LOCATIONS MUST BE DETERMINED IN THE FIELD. SMC ASSUMES NO RESPONSIBILITY FOR DAMAGES INCURRED AS A RESULT OF UTILITIES OMITTED OR INACCURATELY SHOWN.
- GENERALLY THE LINES IN THE PUBLIC AND PRIVATE WAYS ARE SHOWN AND THE LATERAL CONNECTIONS SERVICING INDIVIDUAL USERS ARE NOT SHOWN. BEFORE DESIGNING FUTURE CONNECTIONS, THE APPROPRIATE UTILITIES MUST BE CONSULTED.
- BEFORE CONSTRUCTION, ALL UTILITIES, PUBLIC AND PRIVATE, MUST BE NOTIFIED (SEE MASSACHUSETTS GENERAL LAWS, CHAPTER 82 SECTION 40.) CALL "DIG SAFE" 1 (888) 344-7233 HTTP://WWW.DIGSAFE.COM
- PARCEL LINES AND ASSESSOR INFORMATION WERE COMPILED FROM INFORMATION PROVIDED BY THE TOWN OF WATERTOWN ASSESSOR'S OFFICE.

SITE PREPARATION AND SOIL MANAGEMENT NOTES:

- A DESIGNATED EXCAVATE DISPOSAL AREA HAS BEEN INCLUDED AS SHOWN ON THE DRAWINGS. ALL SUBGRADE MATERIALS EXCAVATED BELOW THE TOP 12 INCHES FROM FINISHED GRADE SHALL BE PLACED IN THIS AREA AND COVERED WITH 2 FEET OF COMMON FILL, 6 INCHES SANDY GRAVEL, AND 6 INCHES OF TOPSOIL FOR A TOTAL OF 3 FEET OF COVER.
- REMOVAL AND LEGAL DISPOSAL MATERIALS IDENTIFIED FOR OFF-SITE REMOVAL. REMOVALS FOR OFF-SITE REMOVAL SHALL BE LIMITED TO EXISTING BOLLARDS, POURED IN PLACE SURFACING, BITUMINOUS CONCRETE, AND EXISTING CONCRETE SHALL BE REMOVED. NO SOILS SHALL BE REMOVED FROM THE SITE. SEE SPECIAL SITE CONSIDERATIONS AND SOILS EXCAVATE HANDLING IN SPECIFICATION SECTION 01010.
- CONTRACTOR SHALL VERIFY ALL UNDERGROUND UTILITIES IMPACTING WORK AND INFORM THE ENGINEER WITHIN 24 HOURS UPON DISCOVERY OF ALL PIPES, CONDUITS, AND INFRASTRUCTURE NOT NOTED ON EXISTING CONDITIONS PLAN PRIOR TO CONTINUING WITH EXCAVATION ACTIVITIES.
- CONTRACTOR SHALL CALL DIG SAFE AT 1.888.344.7233 FOR NOTIFICATION AND APPROVAL OF EXCAVATION ACTIVITIES PRIOR TO CONSTRUCTION ACTIVITIES.
- ALL AREAS OUTSIDE THE LIMIT OF WORK SHALL BE PROTECTED AT ALL TIMES.
- INSTALL INLET PROTECTION AND SEDIMENTATION BARRIERS PRIOR TO COMMENCEMENT OF WORK.
- INSPECT INLET PROTECTION AND SEDIMENTATION BARRIERS WEEKLY AND AFTER ALL STORM EVENTS OF ½ INCH OR GREATER AND REPAIR AS NEEDED AND AS DIRECTED BY THE ENGINEER.
- SEDIMENTATION BARRIERS SHALL REMAIN IN PLACE UNTIL ALL DISTURBED AREAS ARE STABILIZED.
- ALL EXISTING PAVEMENT AND WALKWAYS TO BE PROTECTED THAT ARE DISTURBED BY THIS CONTRACT SHALL BE PROMPTLY REPAIRED IN A MANNER APPROVED BY ENGINEER IN ACCORDANCE WITH SPECIFICATIONS
- UPON COMPLETION OF CONSTRUCTION ACTIVITIES INSPECT AND CLEAN OUT DRAINAGE SYSTEMS TO THE SATISFACTION OF THE ENGINEER.
- CONTRACTOR SHALL PREPARE A STORMWATER POLLUTION PREVENTION PLAN (SWPPP) FOR REVIEW BY THE ENGINEER PRIOR TO THE BEGINNING OF ALL CONSTRUCTION ACTIVITIES. THE CONTRACTOR SHALL MAINTAIN A COPY OF THE SWPPP ON SITE AT ALL TIMES. NPDES PERMIT NUMBER SHALL BE POSTED IN A POSITION TO BE PUBLICLY VISIBLE AT ALL TIMES.
- REMOVE TOPSOIL IN AREAS OF WORK. TOPSOIL MAY BE UTILIZED IN LAWN AND LANDSCAPE AREAS PROVIDED IT MEETS THE REQUIREMENTS OF "LOAM" AS SPECIFIED.

SEQUENCE OF SITE PREPARATION

- INITIATE DEMOLITIONS, REMOVALS, CLEARING, AND GRUBBING ONLY AFTER ALL SITE PREPARATION AND SEDIMENT CONTROL MEASURES HAVE BEEN INSTALLED.
- ESTABLISH LOCATIONS FOR EQUIPMENT AND MATERIAL STAGING INCLUDING AREA FOR STORING AND CLEANING SALVAGED MATERIAL ON-SITE.
- PREPARE AREAS TO ACCEPT FUTURE EXCAVATE MATERIAL.
- INSTALL TEMPORARY CONSTRUCTION FENCE AROUND DESIGNATED EXCAVATE DISPOSAL AREA.
- MAINTAIN ON SITE ADDITIONAL TEMPORARY CONSTRUCTION FENCE AND STEEL PLATES FOR SECURING FOUNDATION EXCAVATIONS TO ENSURE THE SAFETY OF THE PUBLIC.

GRADING AND DRAINAGE NOTES:

- VERTICAL DATUM BASED ON BENCHMARKS SHOWN ON C-1. CONTRACTOR SHALL FIELD VERIFY ELEVATION OF BENCHMARKS PRIOR TO STAKING FINISHED GRADES.
- CONTRACTOR SHALL NOTIFY ENGINEER OF ANY OBSTRUCTIONS ENCOUNTERED DURING EXCAVATION ACTIVITIES.
- ALL AREAS DISTURBED BY CONSTRUCTION ACTIVITIES BEYOND THE LIMIT OF WORK SHALL BE REPAIRED AT THE CONTRACTOR'S EXPENSE IN A MANNER APPROVED BY THE ENGINEER.
- PATHWAYS AND WALKWAYS SHALL HAVE A MAX. CROSS SLOPE OF 2% AND MAX. LONGITUDINAL SLOPE OF 5%.
- CONTRACTOR SHALL BE RESPONSIBLE FOR INSTALLATION AND MAINTENANCE OF GRADE STAKES AS APPROVED BY THE ENGINEER. CONTRACTOR SHALL BE RESPONSIBLE FOR A FINAL FIELD CHECK OF FINISHED GRADES AS APPROVED BY THE ENGINEER PRIOR TO INSTALLATION OF FINAL PAVEMENT.
- PITCH EVENLY BETWEEN SPOT GRADES. ALL PAVED AREAS MUST PITCH TO DRAIN AT A MINIMUM SLOPE OF ¼" PER FOOT. ANY DISCREPANCIES NOT ALLOWING THIS TO OCCUR SHALL BE REPORTED TO THE ENGINEER PRIOR TO CONTINUING WORK.
- WHERE NEW PAVING MEETS EXISTING PAVING, MEET LINE AND GRADE OF EXISTING WITH NEW PAVEMENT.
- CONTRACTOR SHALL PROVIDE DUST CONTROL FOR CONSTRUCTION OPERATIONS AS APPROVED BY THE ENGINEER.
- ALL POINTS OF CONSTRUCTION EGRESS OR INGRESS SHALL BE MAINTAINED TO PREVENT TRACKING OR FLOWING OF SEDIMENT ONTO PUBLIC ROADS.
- ADJUST ALL DRAINAGE AND SEWER STRUCTURE FRAMES AND GRATES/COVERS AS APPLICABLE TO MEET PROPOSED GRADE.
- PROVIDE LOAM AND SEED AS SPECIFIED, IN ALL AREAS WITHIN LIMIT OF DISTURBANCE THAT ARE NOT PAVED, COVERED WITH STRUCTURES, OR ARE DESIGNATED PLANTING BEDS.

LAYOUT AND MATERIALS NOTES:

- FOR LAYOUT PURPOSES AND TO ESTABLISH THE COORDINATE SYSTEM HORIZONTAL CONTROL POINTS ARE SHOWN ON SHEETS C-1 AND C-2.
- EXISTING SURVEY MONUMENTS OR CONTROL POINTS SHALL BE FLAGGED AND PROTECTED THROUGHOUT THE CONSTRUCTION CONTRACT UNLESS OTHERWISE APPROVED BY THE ENGINEER. DAMAGED OR MISSING MONUMENTS OR CONTROL POINTS SHALL BE REPLACED AT THE CONTRACTOR'S EXPENSE.
- PAVEMENT LIMITS, LOCATIONS OF STRUCTURES, FENCE, WALLS, CURBS, PLANT MATERIALS ARE APPROXIMATE. FINAL LOCATIONS SHALL BE STAKED IN THE FIELD AND APPROVED BY THE ENGINEER BASED ON ACTUAL SITE CONDITIONS.
- ALL DISTURBED AREAS NOT RECEIVING NEW BITUMINOUS CONCRETE, CONCRETE PAVEMENT SHALL RECEIVE 6-IN LAYER LOAM AND SEED.
- PATHWAYS AND WALKWAYS SHALL HAVE A MAXIMUM LATERAL CROSS SLOPE OF 2% AND A MAXIMUM LONGITUDINAL SLOPE OF 5%.
- DIMENSIONS ARE TO FACE OF WALL, FACE OF CURB, EDGE OF PAVEMENT OR TO CENTERLINES UNLESS OTHERWISE SHOWN ON THE DRAWINGS.
- LOCATION OF GRANITE SEAT BLOCKS SHALL BE MARKED IN THE FIELD BY THE CONTRACTOR FOR REVIEW AND APPROVAL BY THE ENGINEER PRIOR TO INSTALLATION.

REV. NO.	DATE	DRWN	CHKD	REMARKS

DESIGNED BY: G. HOWARD
DRAWN BY: J. BRONENKANT
SHEET CHK'D BY: G. HOWARD
CROSS CHK'D BY: S. LANDGREN
APPROVED BY: S. LANDGREN
DATE: FEBRUARY 2023





CITY OF WATERTOWN, MA
FILIPPELLO PARK SPRAY PAD RENOVATION

GENERAL NOTES AND LEGEND

PROJECT NO. 56318-267753
FILE NAME: G001GNLG.DWG
SHEET NO.
G-1

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- LEGEND
- REMOVE AND DISPOSE OF EXISTING SURFACING, AND SUBSURFACE CONCRETE PAD
 - REMOVE AND DISPOSE OF EXISTING CONCRETE PAD
 - REMOVE AND DISPOSE OF EXISTING BITUMINOUS CONCRETE
 - TEMPORARY CONSTRUCTION FENCE

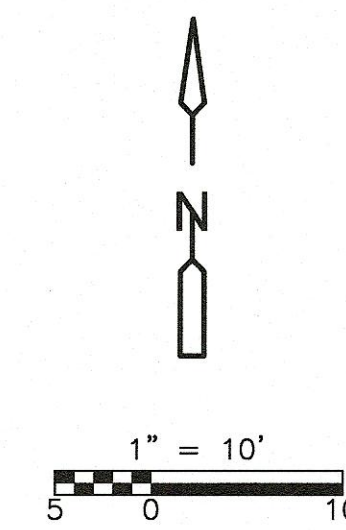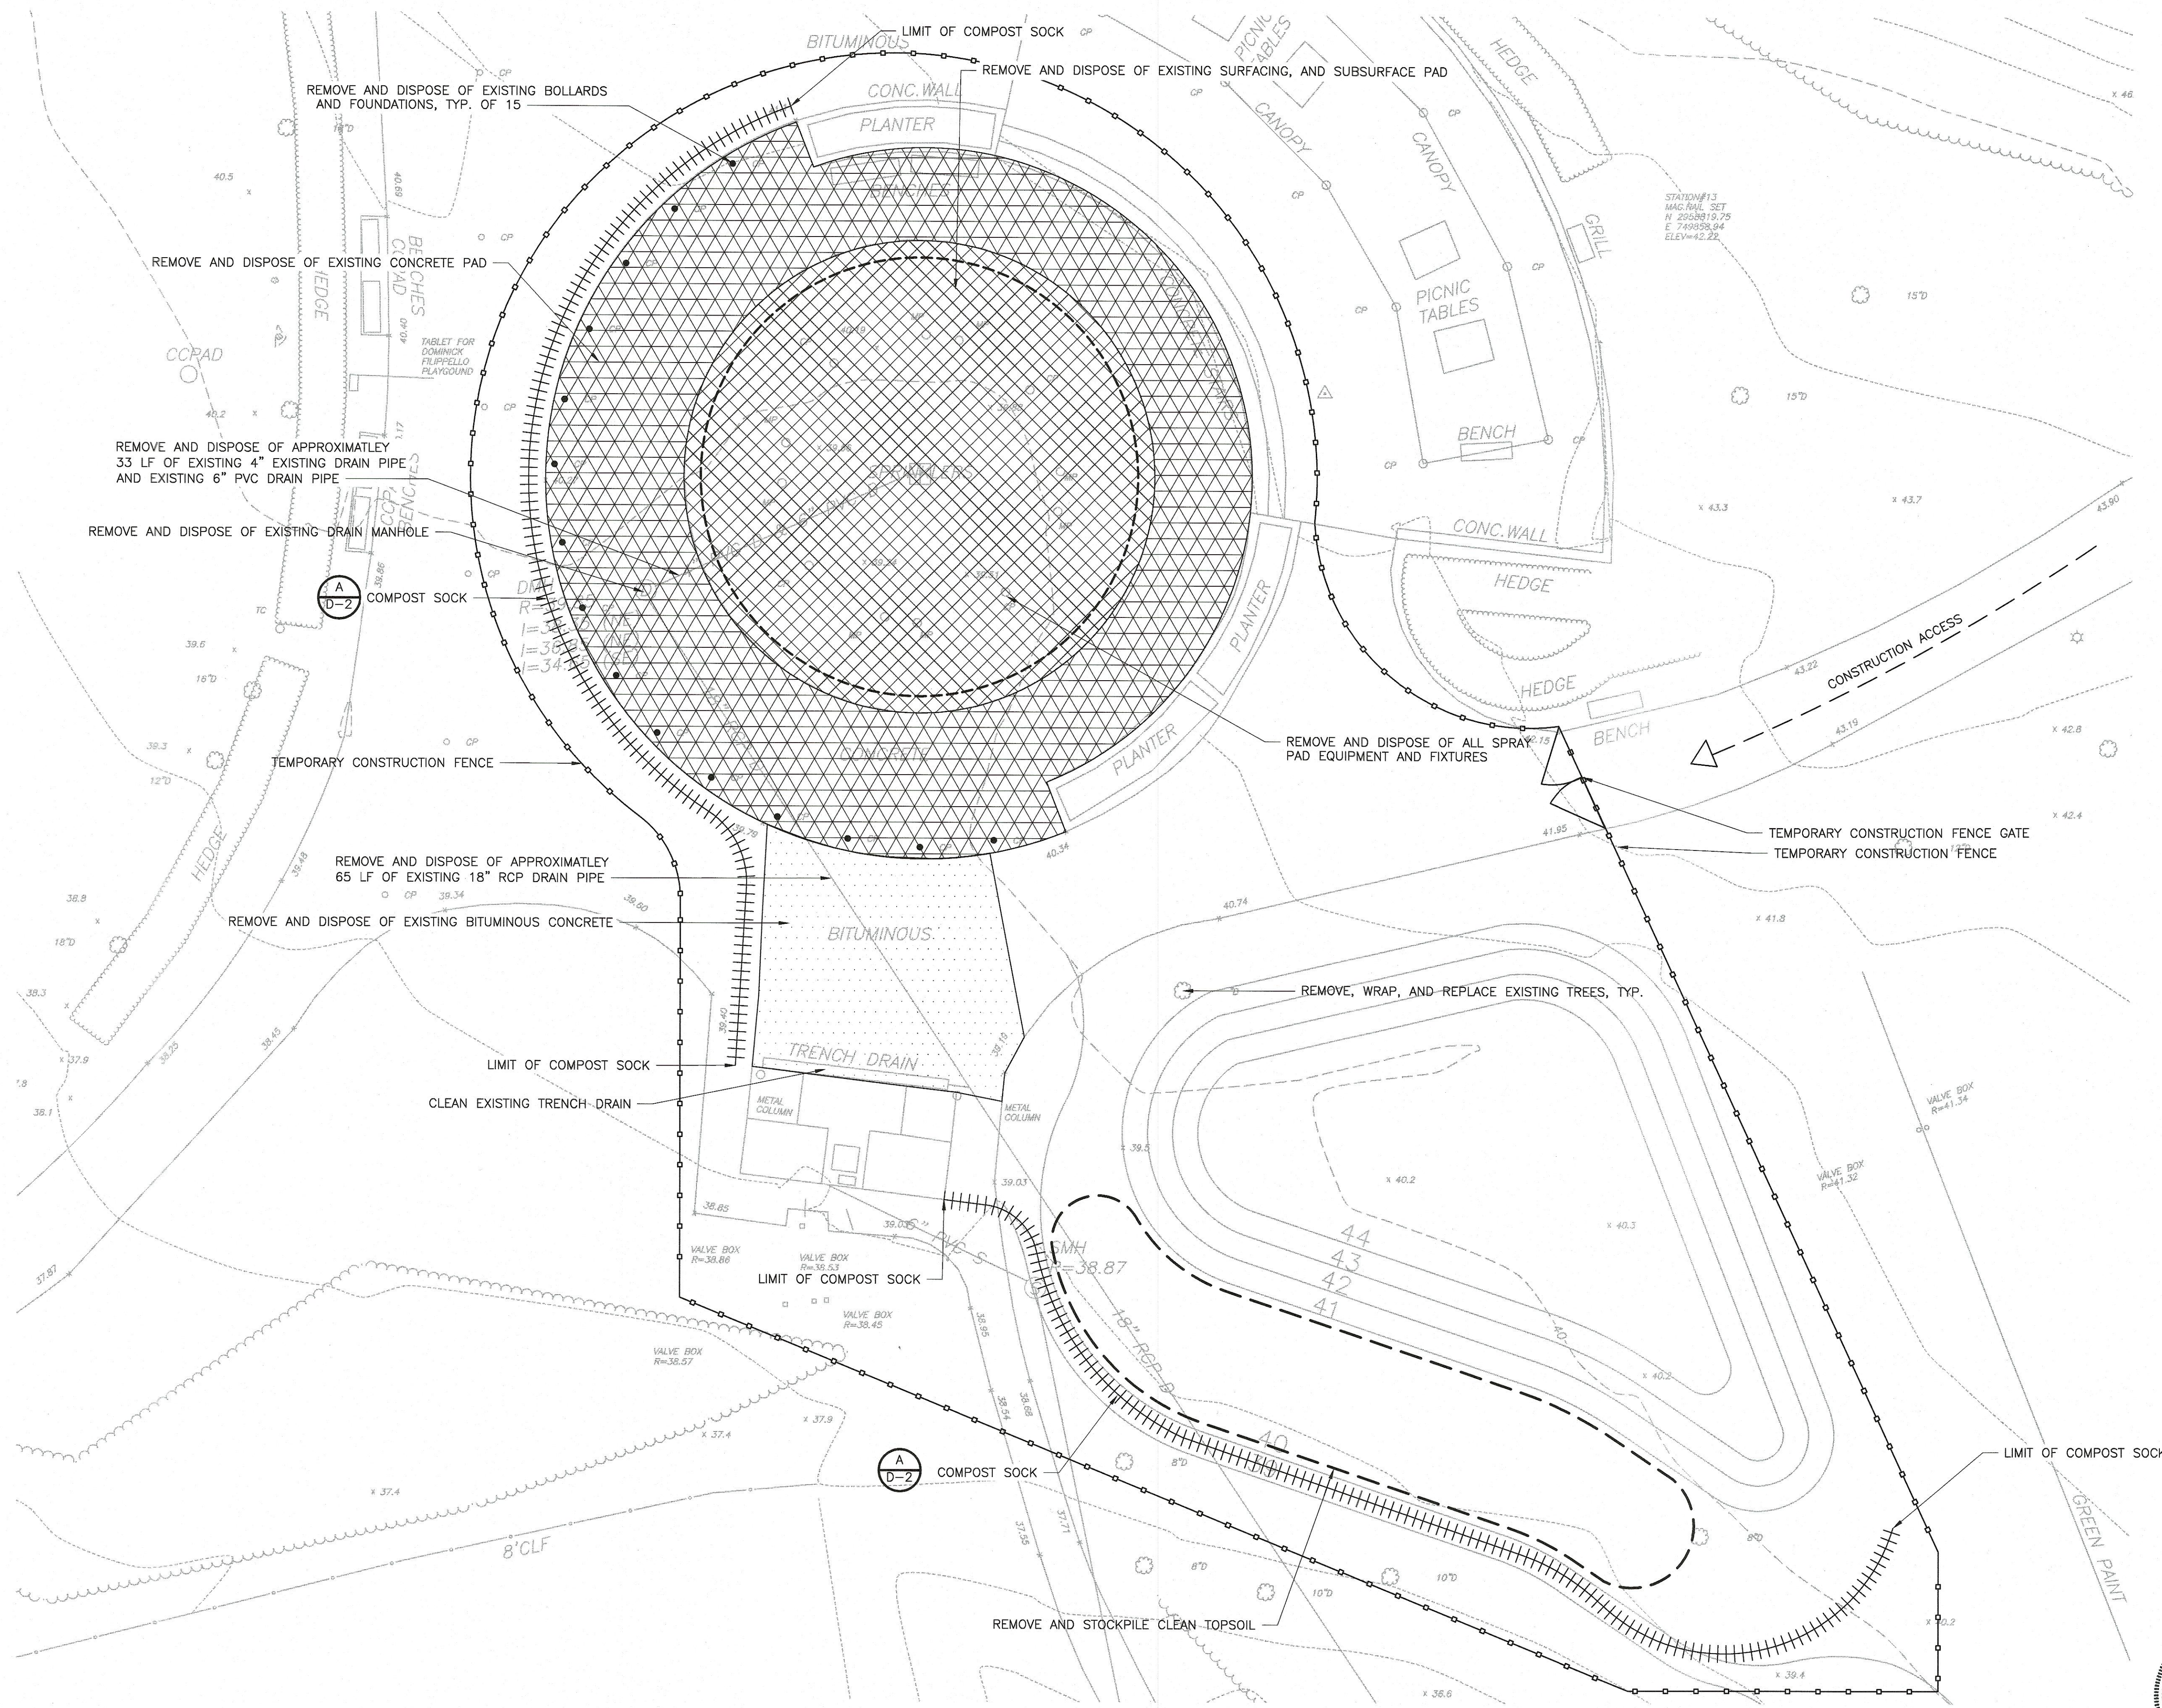

REV.	DATE	DRWN	CHKD	REMARKS

DESIGNED BY: G. HOWARD
DRAWN BY: J. BRONENKANT
SHEET CHK'D BY: G. HOWARD
CROSS CHK'D BY: S. LANDGREN
APPROVED BY: S. LANDGREN
DATE: FEBRUARY 2023





CITY OF WATERTOWN, MA
FILIPPELLO PARK SPRAY PAD RENOVATION


REMOVALS, EROSION, AND
SEDIMENTATION CONTROL PLAN
C-2

PROJECT NO. 56318-267753
FILE NAME: C002STPL.dwg
SHEET NO.
C-2

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LEGEND	
	POROUS POURED IN PLACE SAFETY SURFACING
	CONCRETE PAD
	BITUMINOUS CONCRETE
	EXCAVATE STORAGE AREA

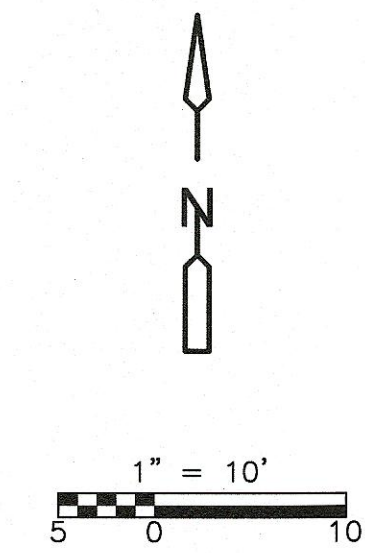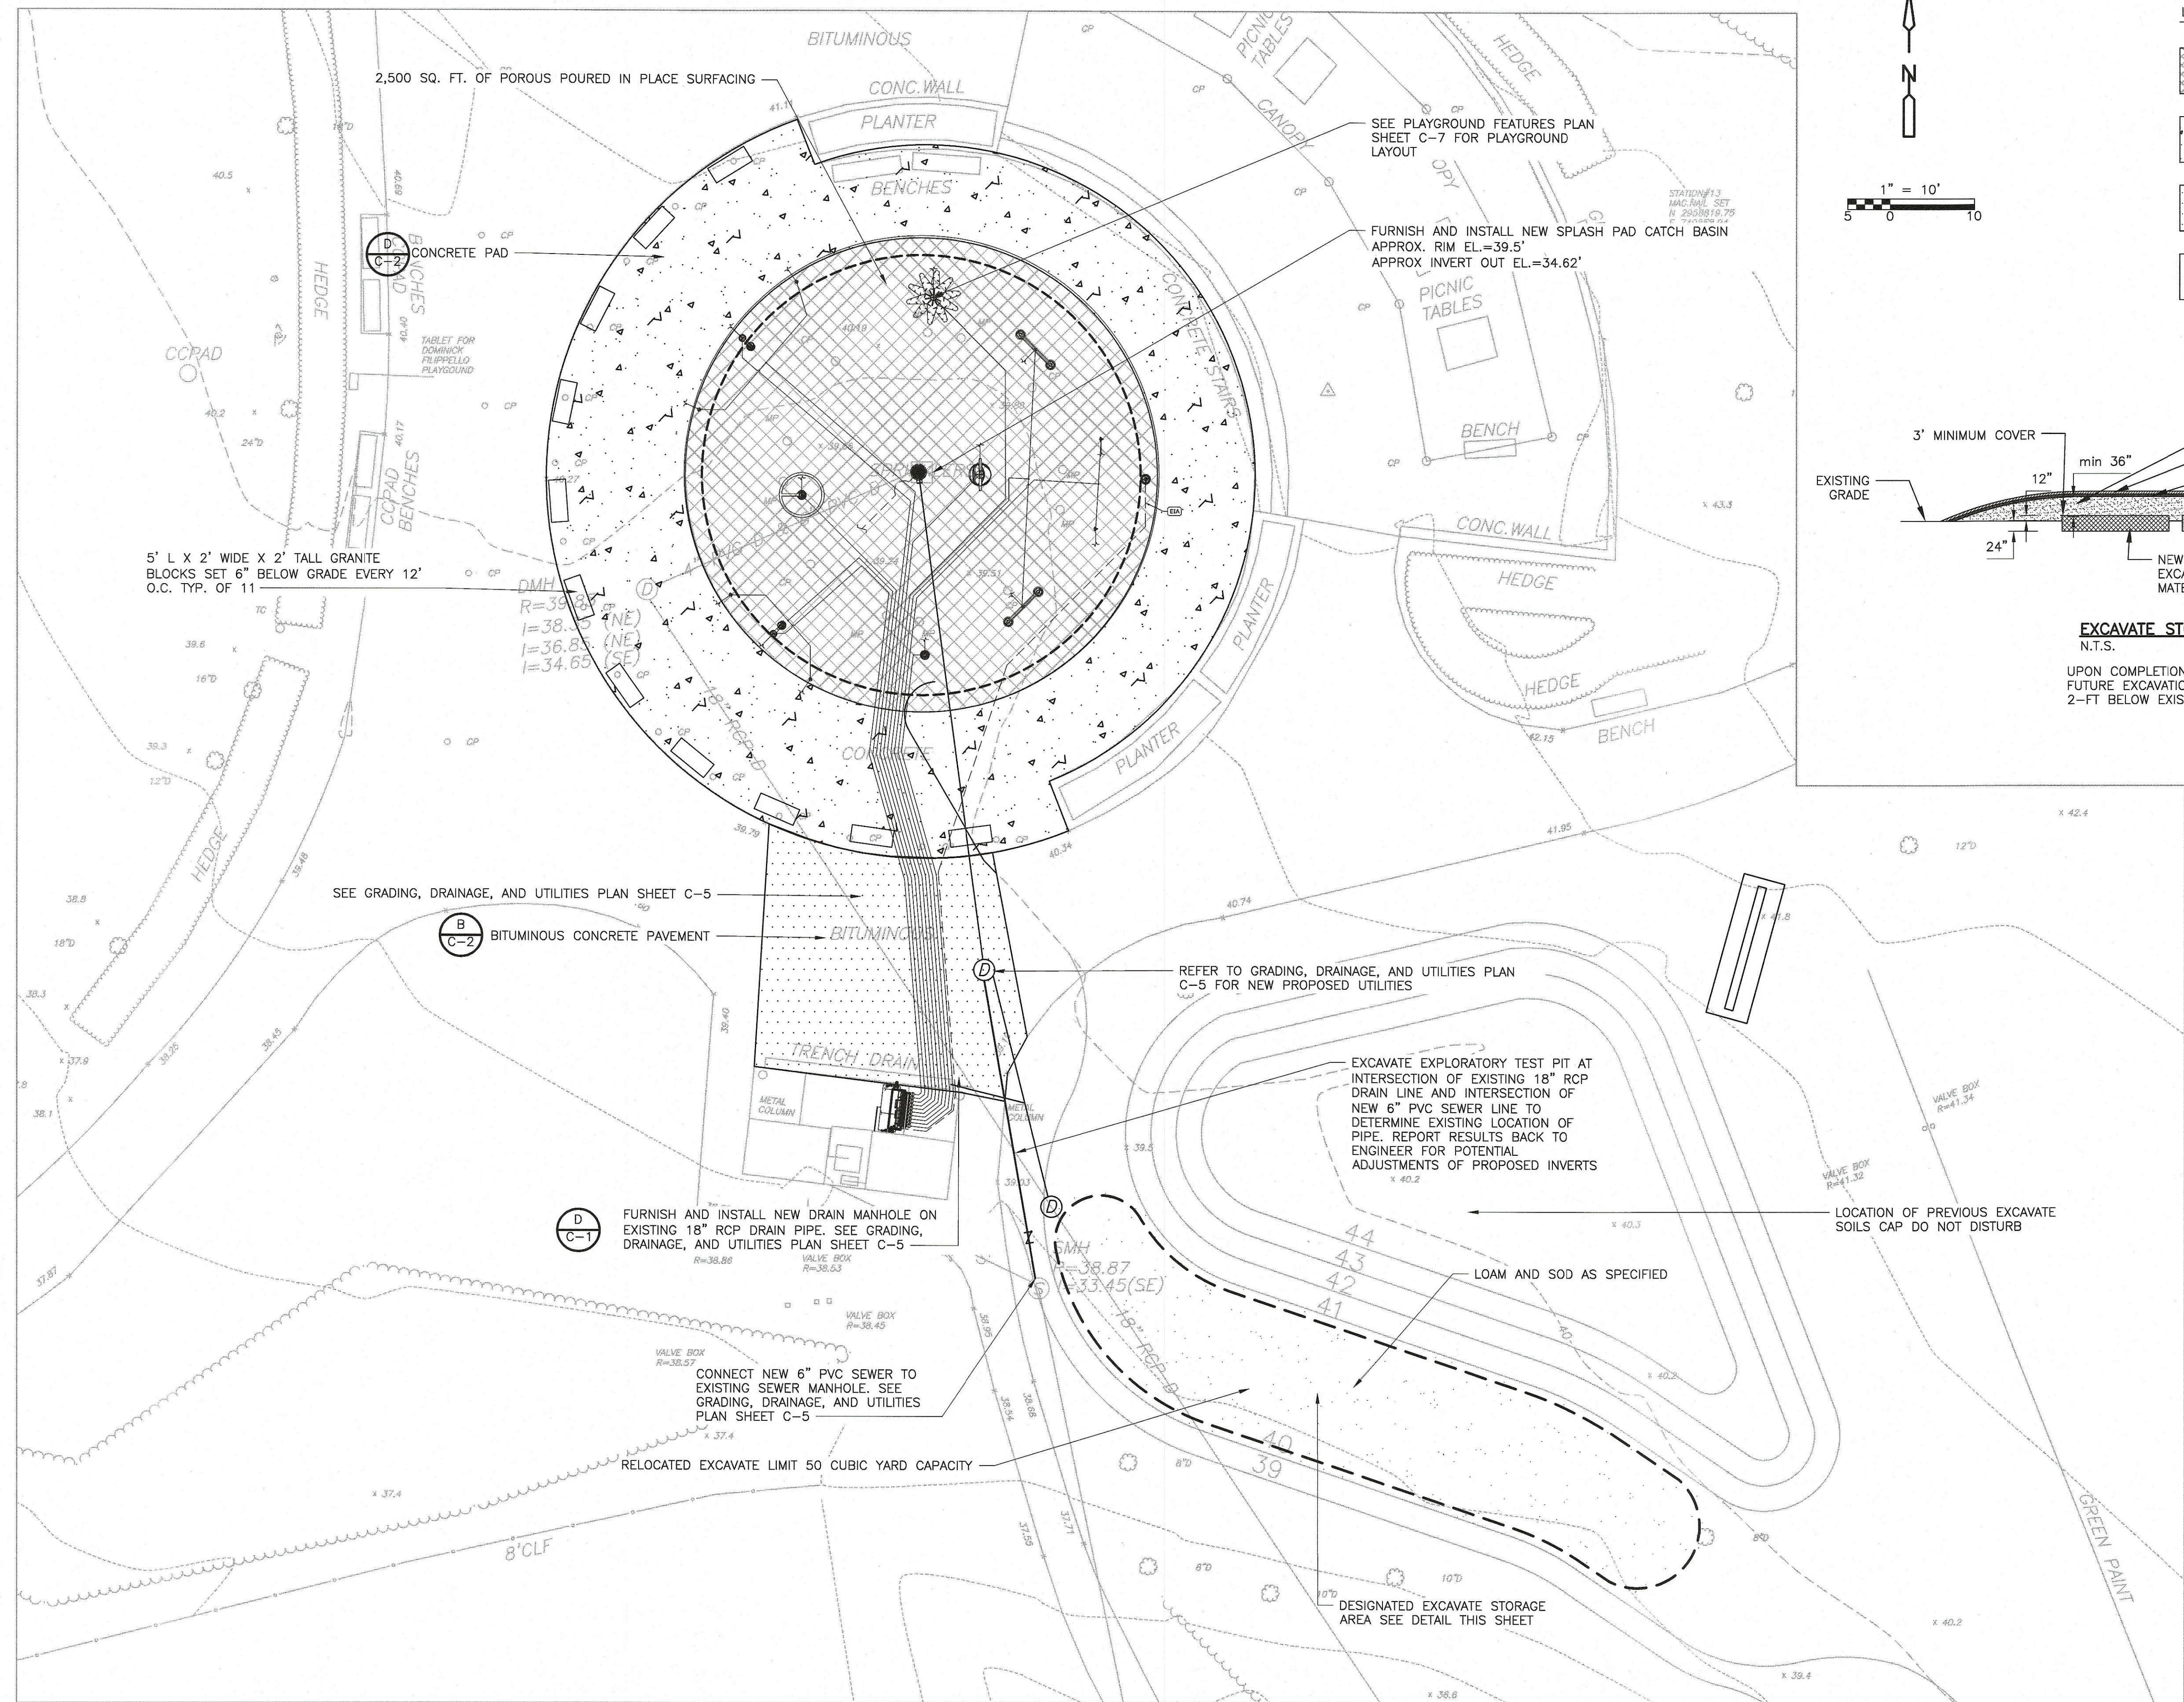

EXCAVATE STORAGE AREA
N.T.S.
UPON COMPLETION OF WORK, NO FUTURE EXCAVATION BEYOND TOP 2-FT BELOW EXISTING GRADE

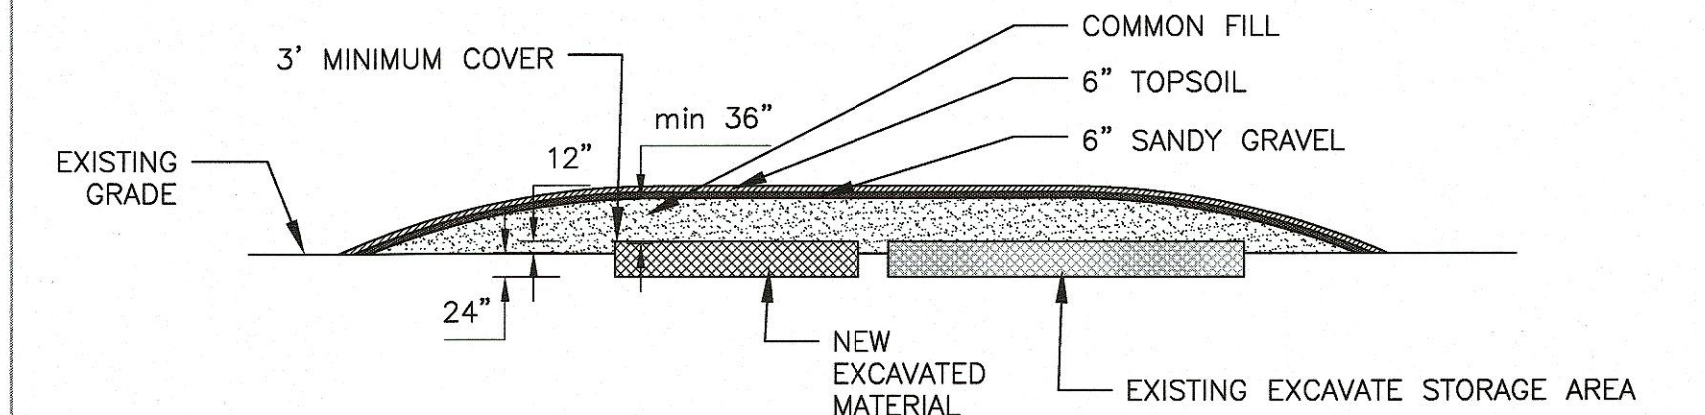REV. NO.	DATE	DRWN	CHKD	REMARKS

DESIGNED BY: G. HOWARD
DRAWN BY: J. BRONENKANT
SHEET CHK'D BY: G. HOWARD
CROSS CHK'D BY: S. LANDGREN
APPROVED BY: S. LANDGREN
DATE: FEBRUARY 2023


CDM Smith
75 State Street
Boston, MA 02109
Tel: (617) 452-8000

CITY OF WATERTOWN, MA
FILIPPELLO PARK SPRAY PAD RENOVATION

MATERIALS PLAN
SHEET NO. **C-3**

PROJECT NO. 56318-267753
FILE NAME: C003STPL.dwg
SHEET NO. **C-3**

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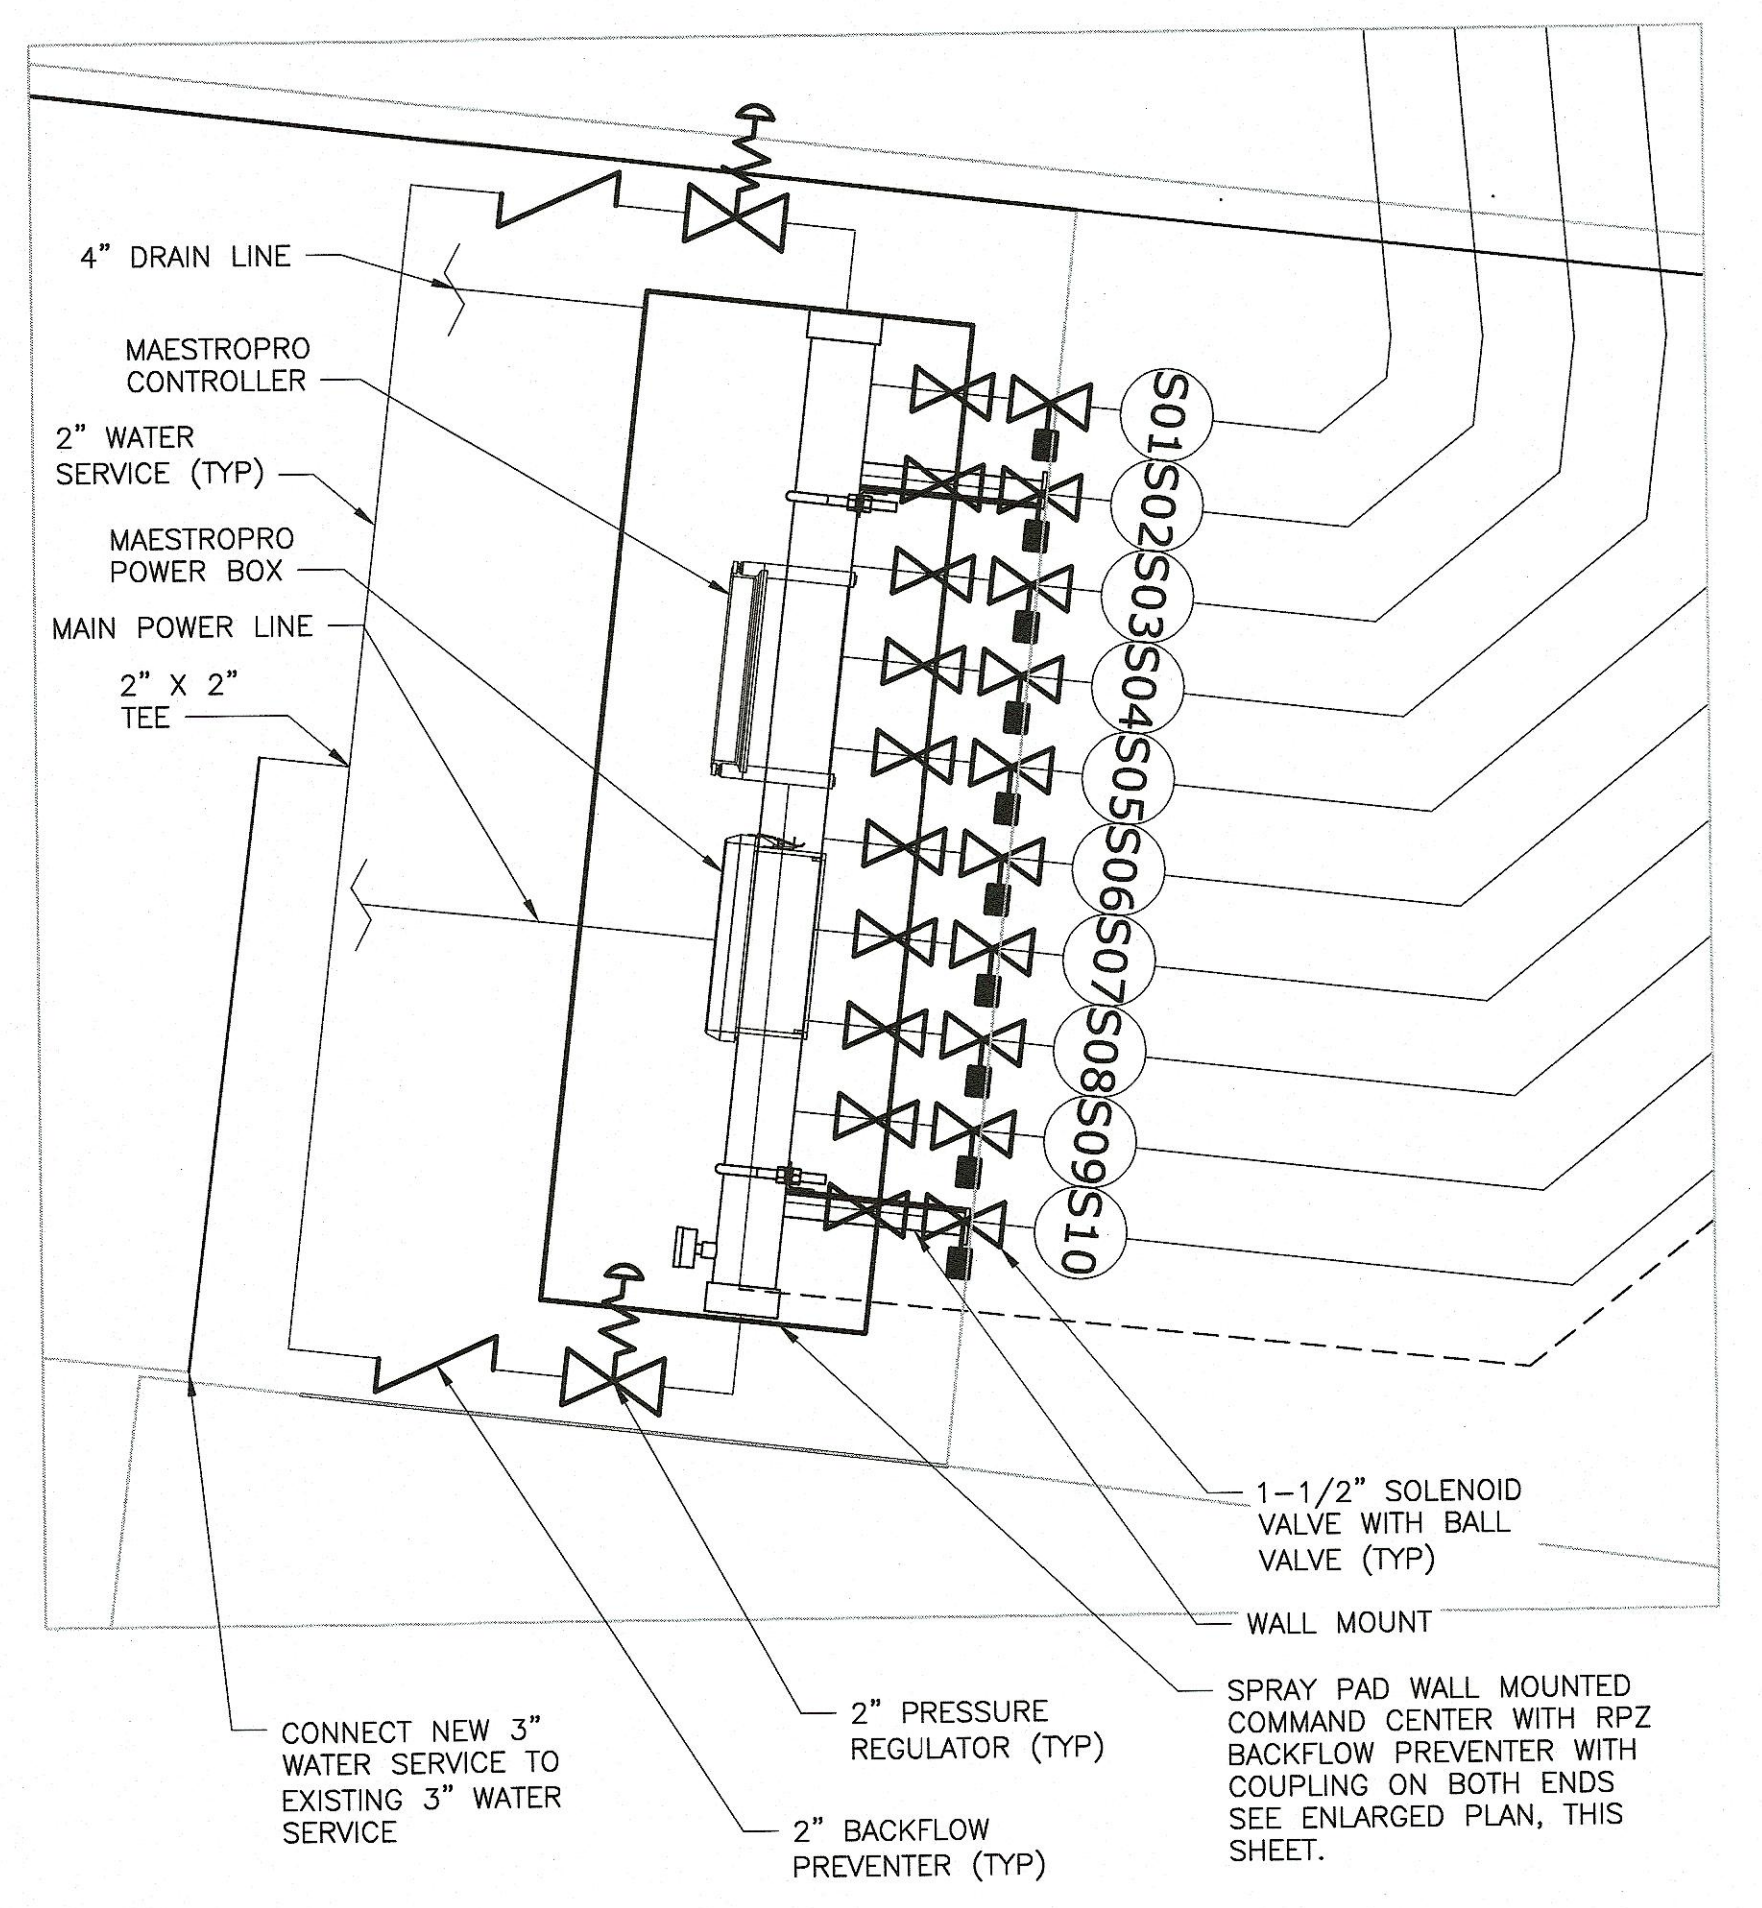
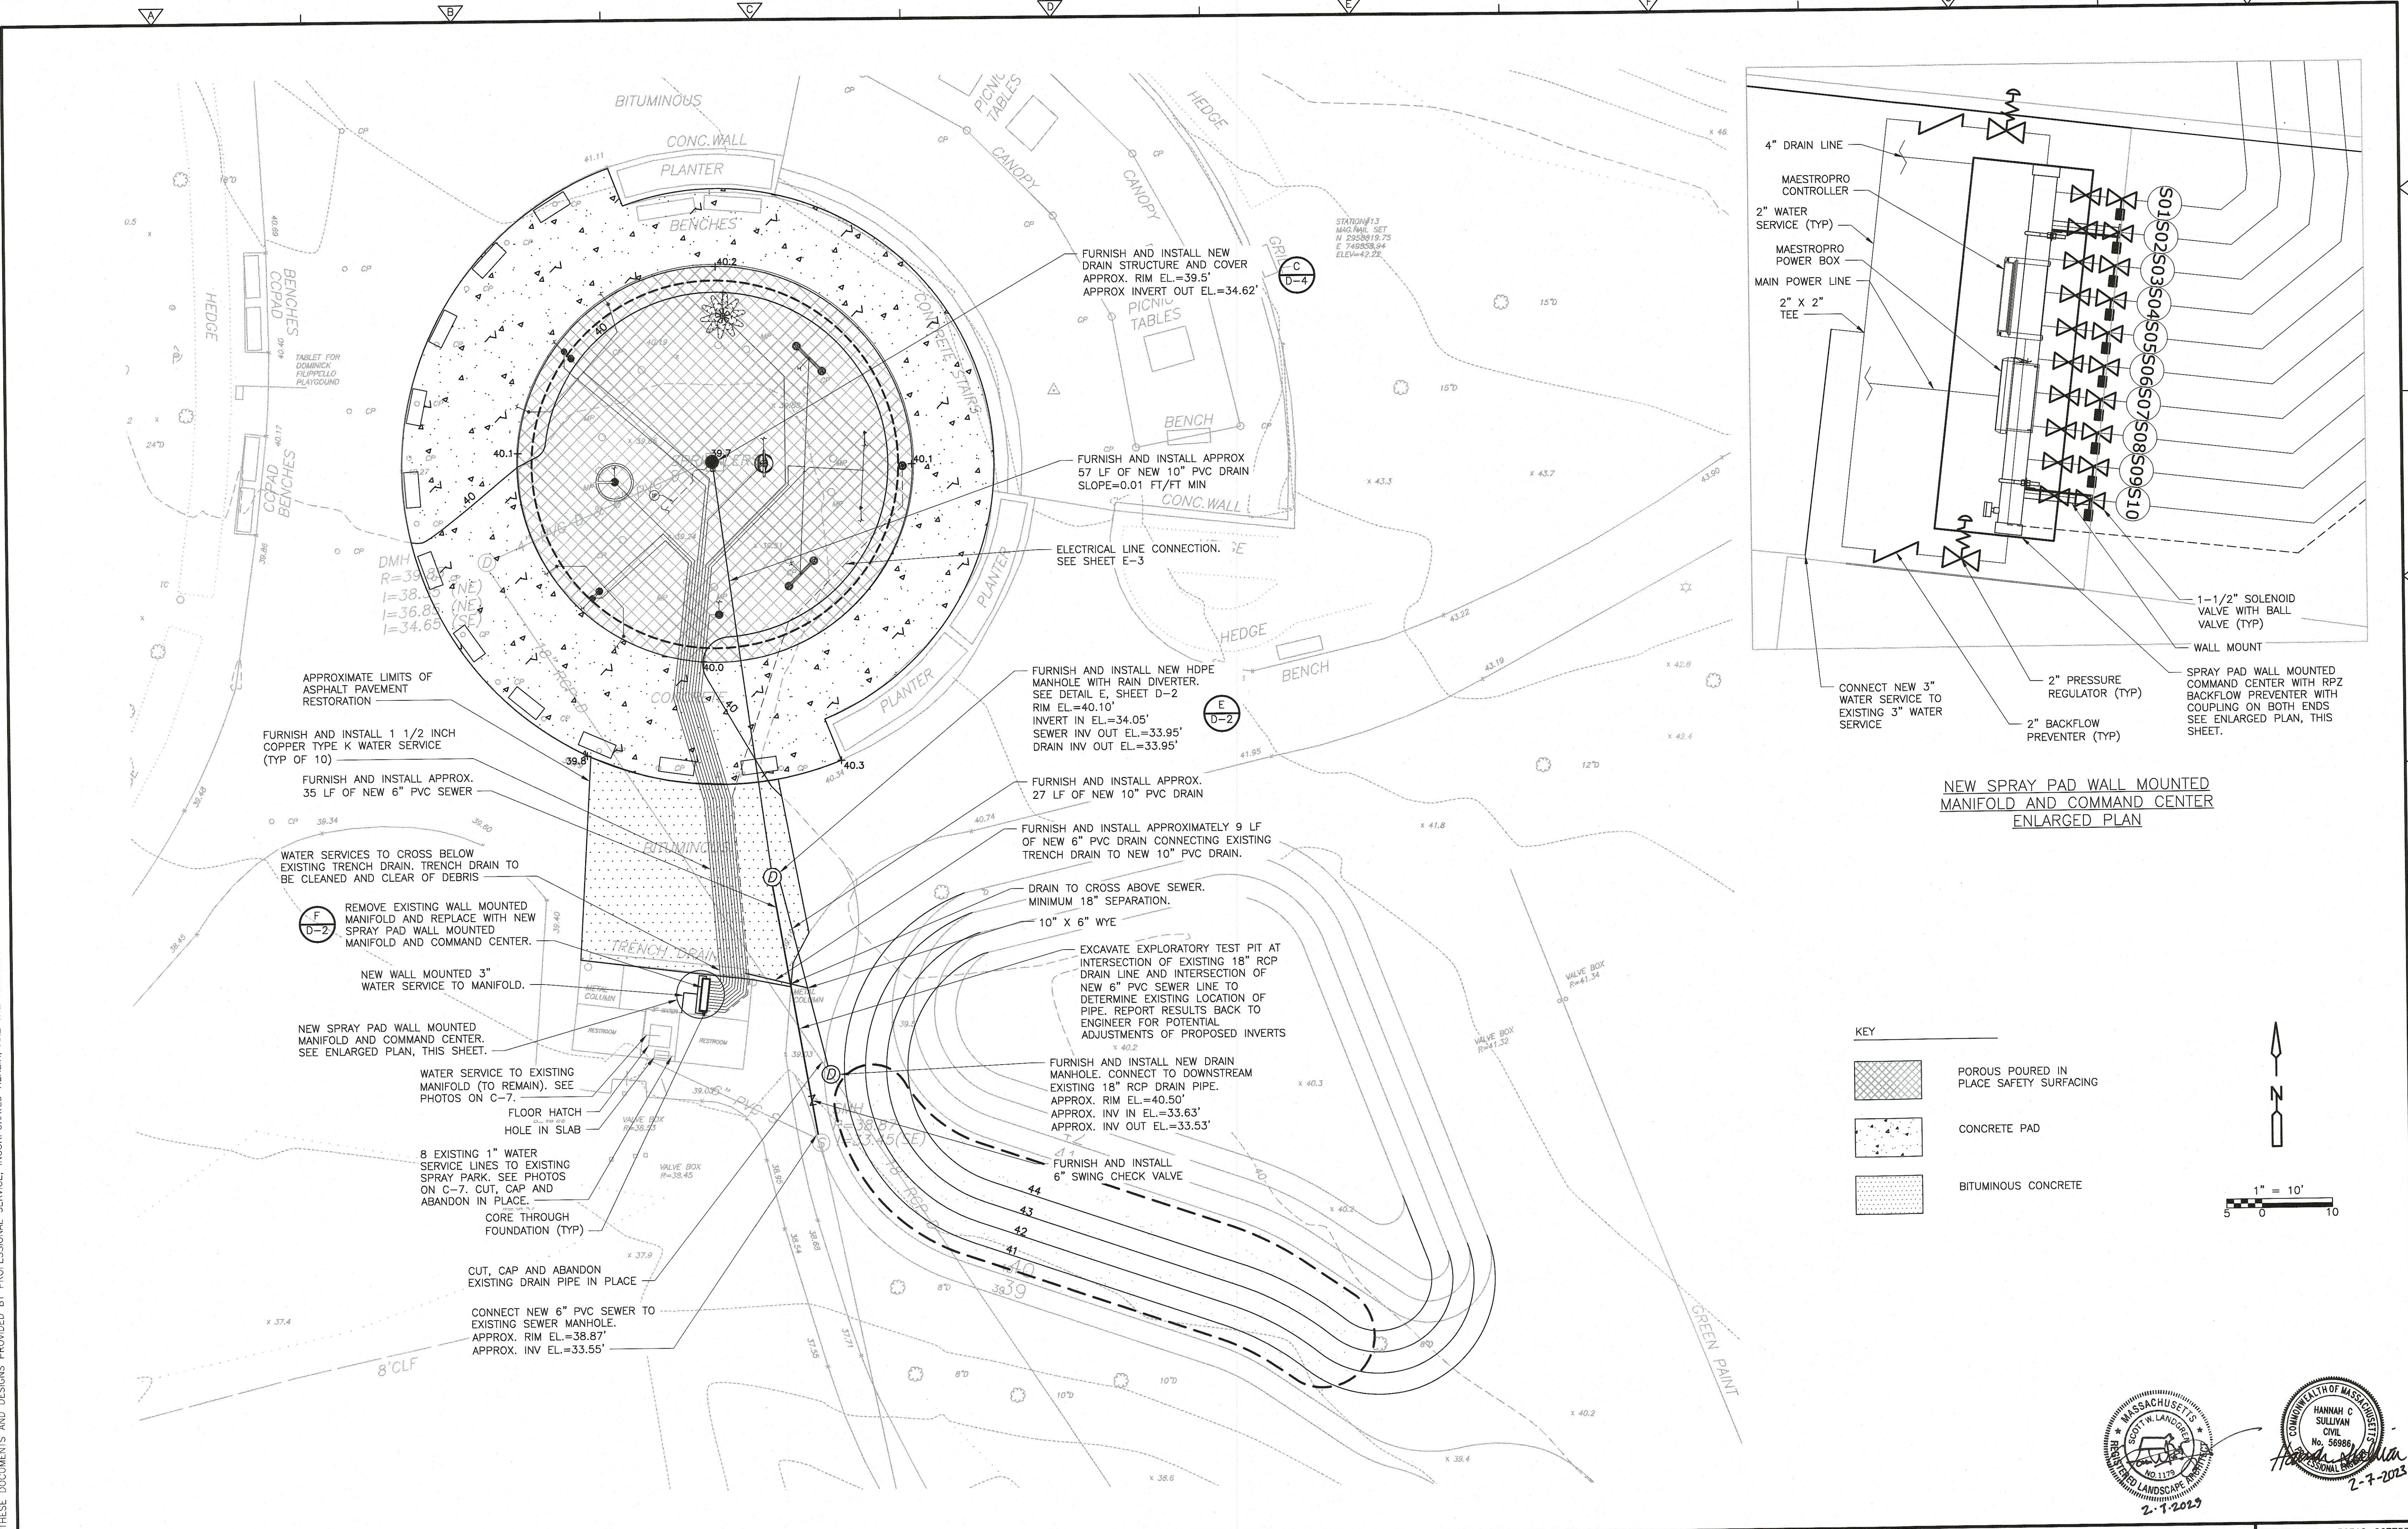
LEGEND

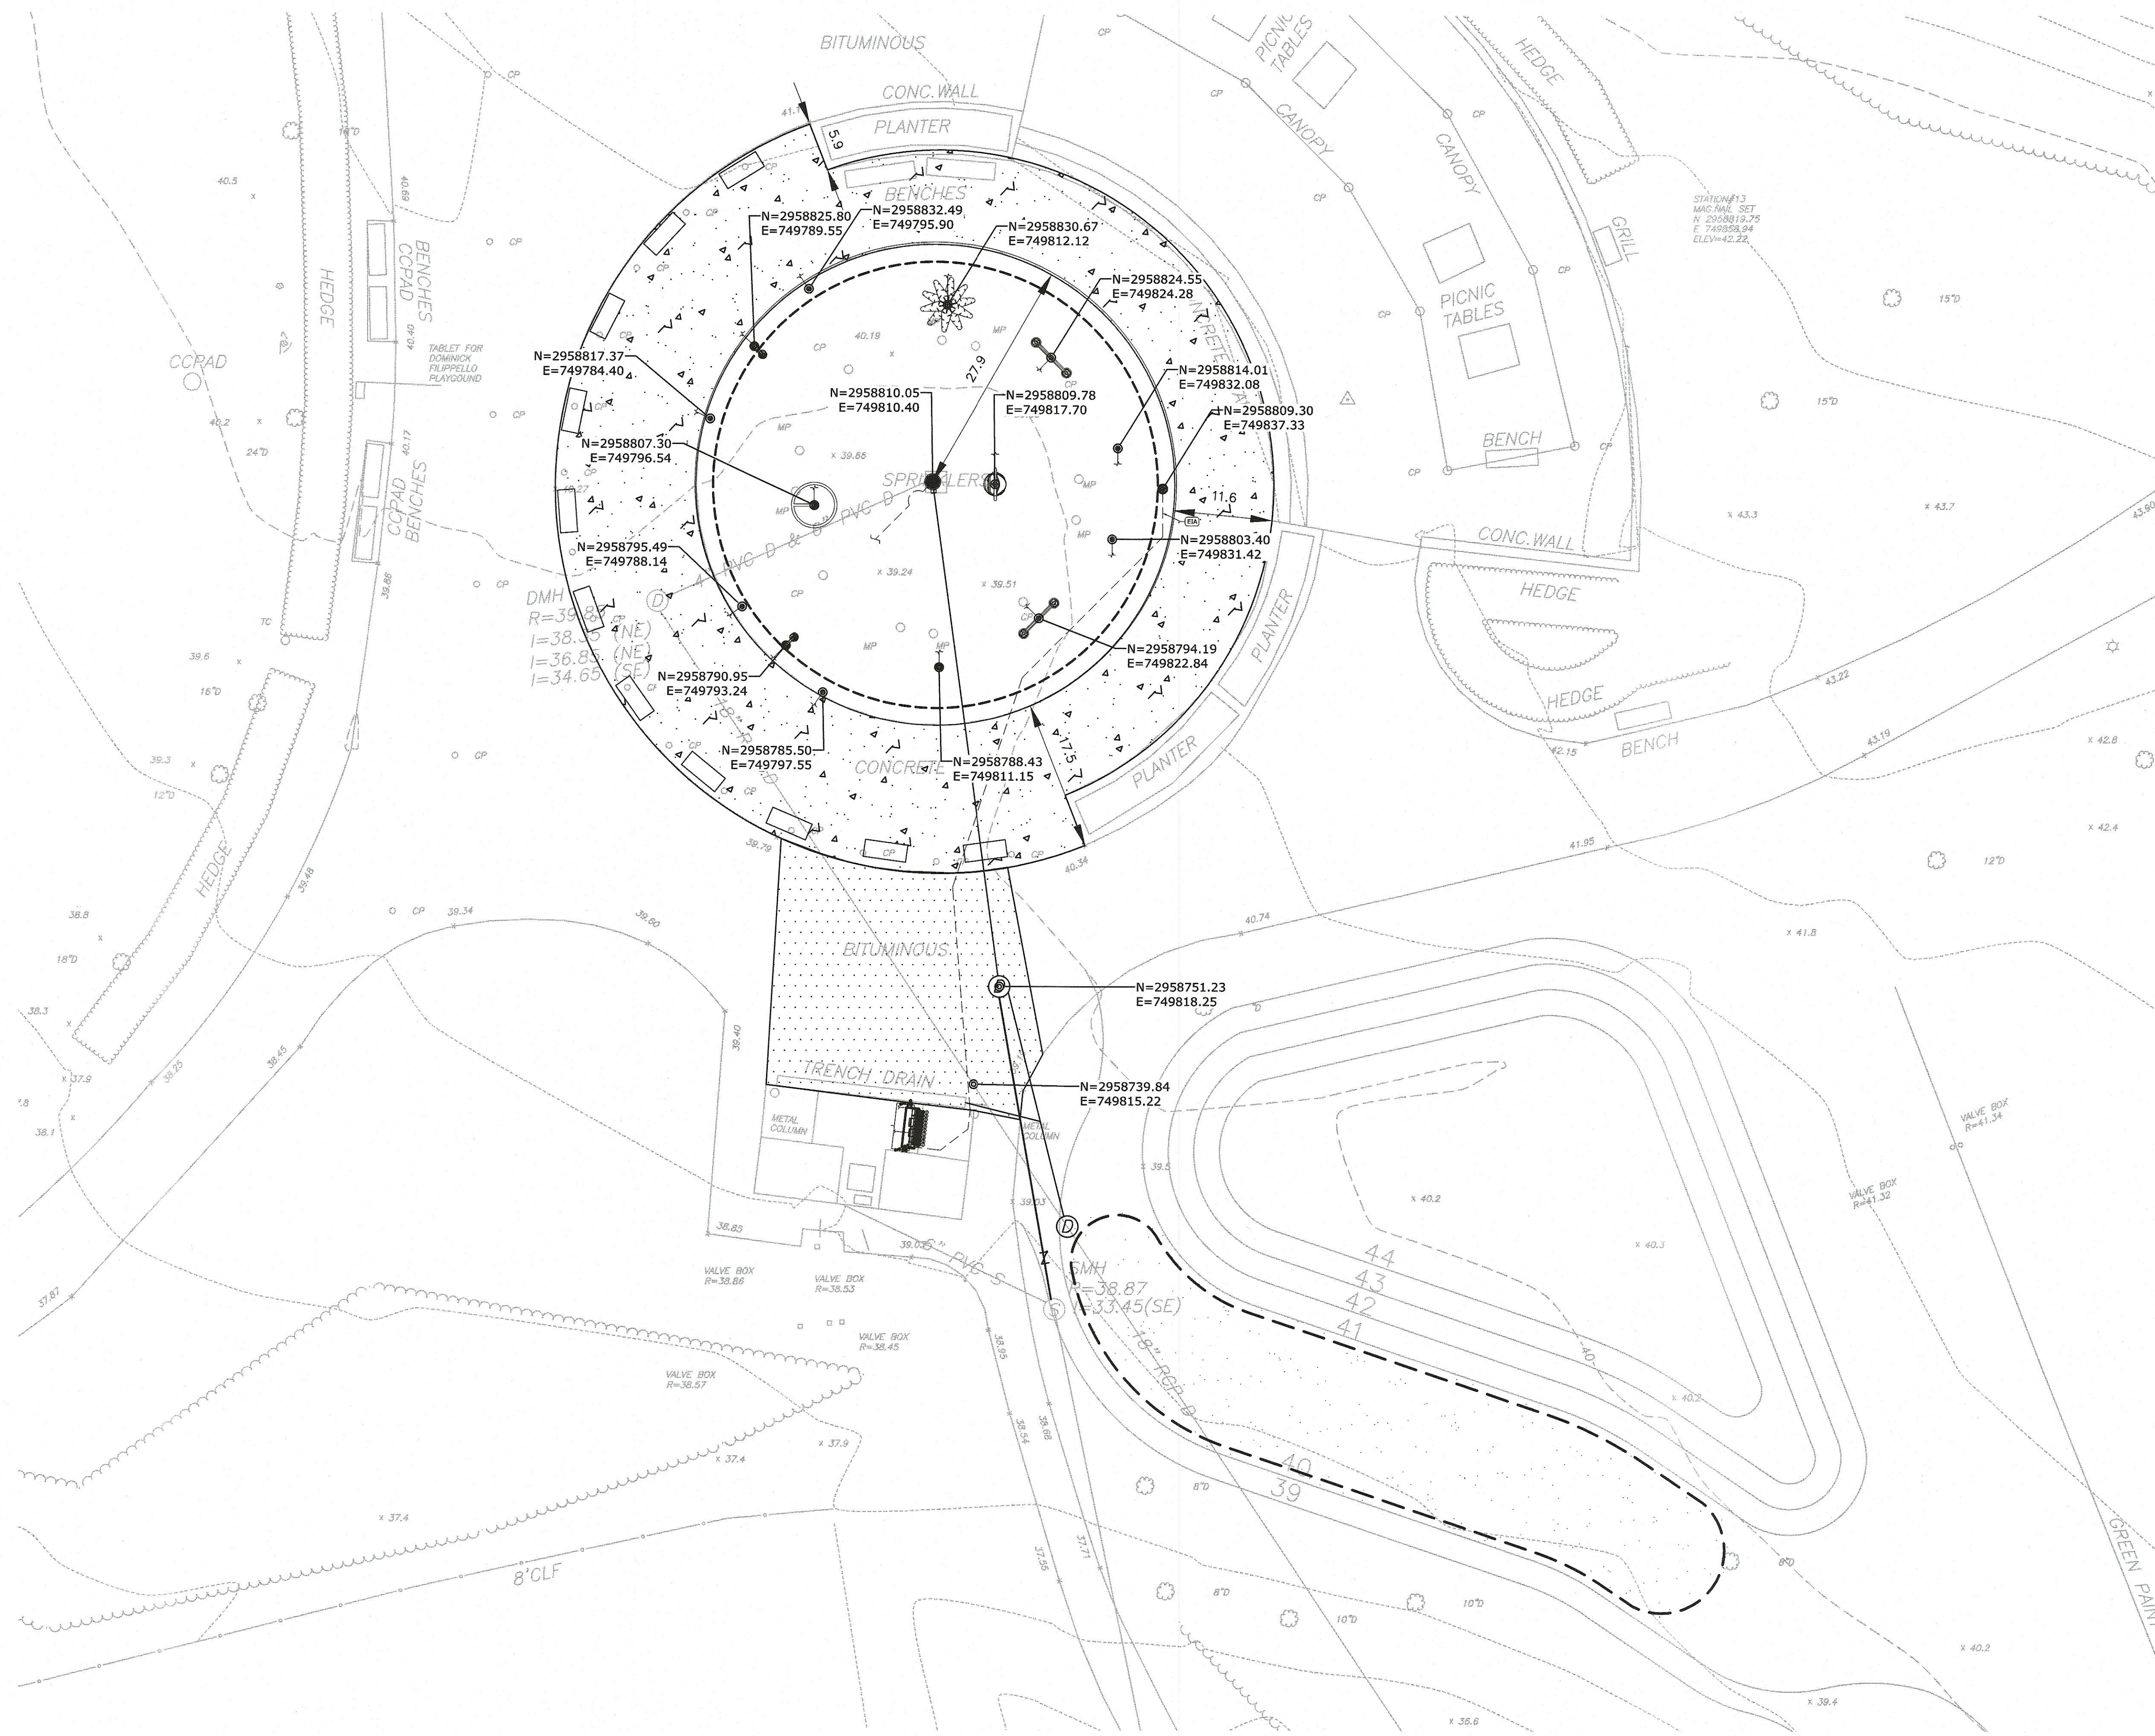- POROUS POURED IN PLACE SAFETY SURFACING
- CONCRETE PAD
- BITUMINOUS CONCRETE





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- KEY
- POROUS POURED IN PLACE SAFETY SURFACING
 - CONCRETE PAD
 - BITUMINOUS CONCRETE



REV. NO.	DATE	DRWN	CHKD	REMARKS

DESIGNED BY: H. SULLIVAN	CDM Smith 75 State Street Boston, MA 02109 Tel: (617) 452-6000
DRAWN BY: H. SULLIVAN	
SHEET CHK'D BY: G. HOWARD	
CROSS CHK'D BY: K. JOHNSTON	
APPROVED BY: H. SULLIVAN	
DATE: FEBRUARY 2023	

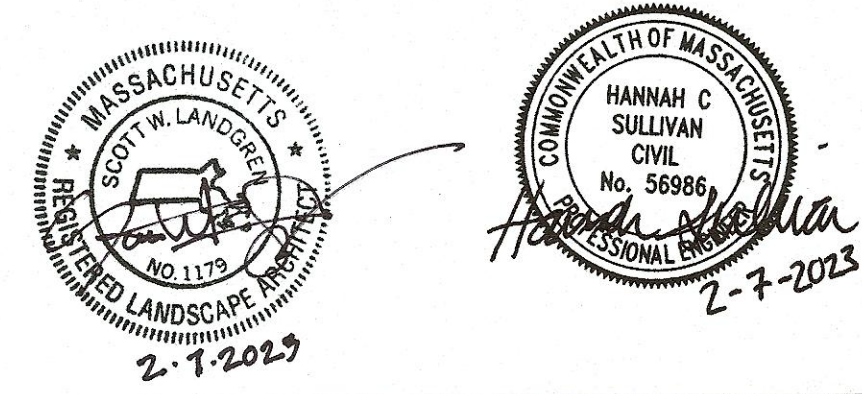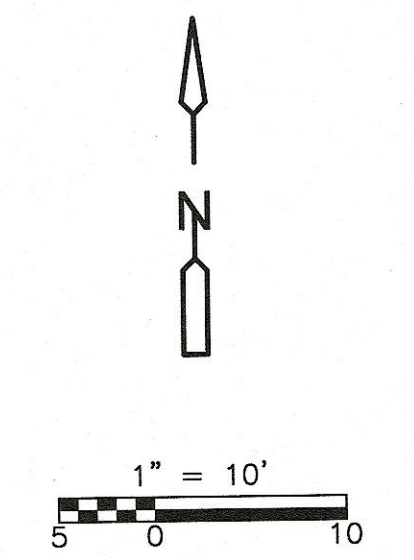CITY OF WATERTOWN, MA

FILIPPELLO PARK SPRAY PAD RENOVATION

GRADING, DRAINAGE, AND UTILITIES PLAN


PROJECT NO. 56318-267753
FILE NAME: C006STPL.dwg
SHEET NO. C-5

**CDM
Smith**
75 State Street
Boston, MA 02109
Tel: (617) 452-6000

PROJECT NO. 56318-267753
FILE NAME: C006STPL.dwg

SHEET NO.

C-6

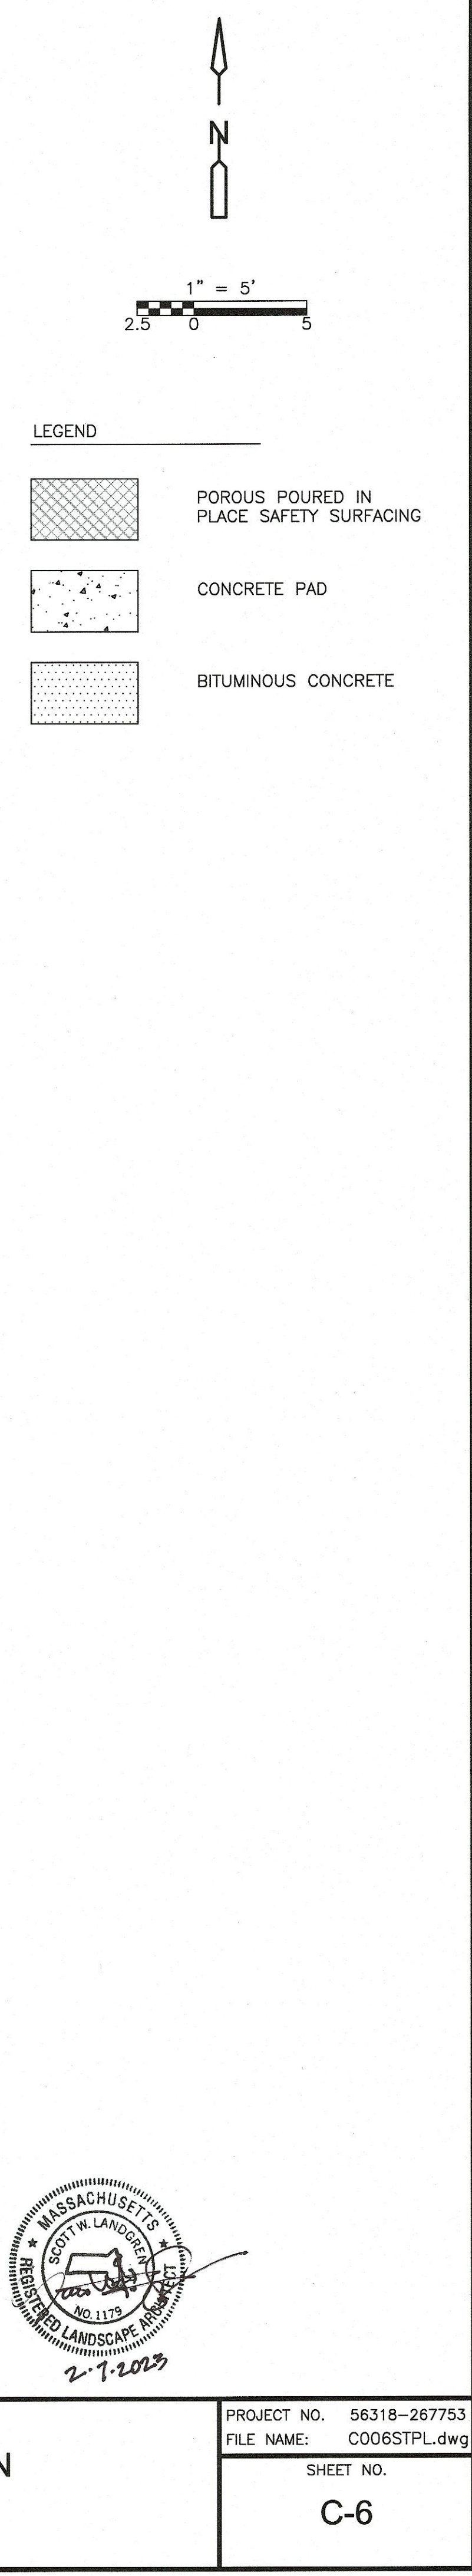

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FLOOR
HATCH



INSIDE UTILITY BUILDING
(VIEW FROM FRONT DOOR)




WATER SERVICE ENTERING
BUILDING (IN FLOOR HATCH)




EXISTING SPRAY PARK
WATER SERVICE MANIFOLD



EXISTING 8 WATER SERVICES
TO SPRAY PARK FEATURES

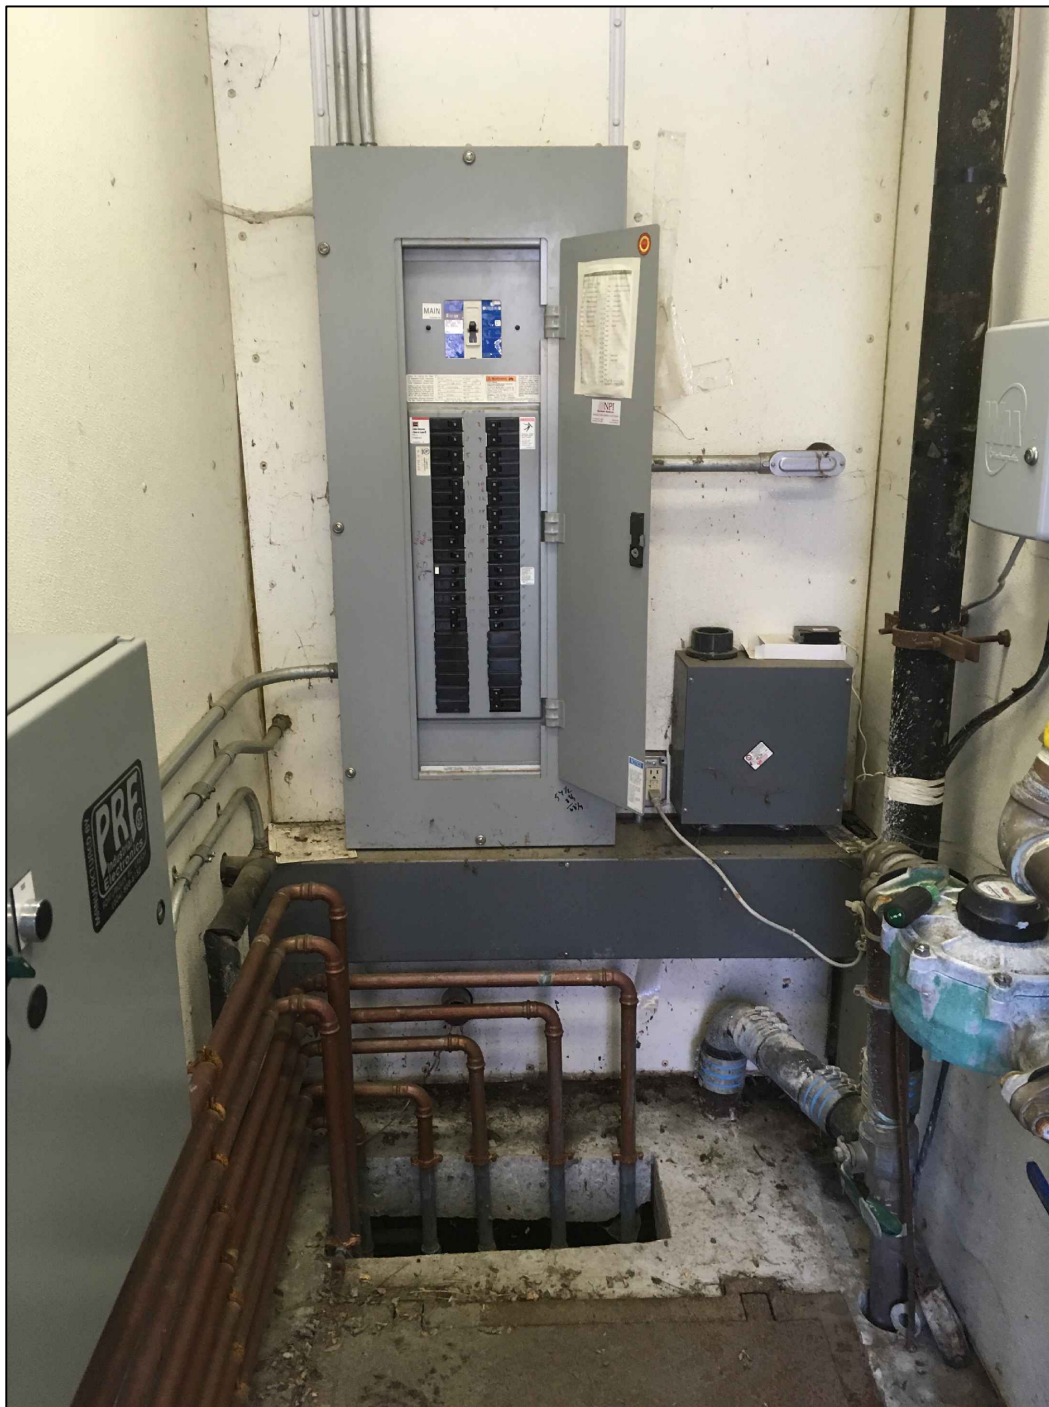

EXISTING 8 WATER SERVICES
TO SPRAY PARK FEATURES

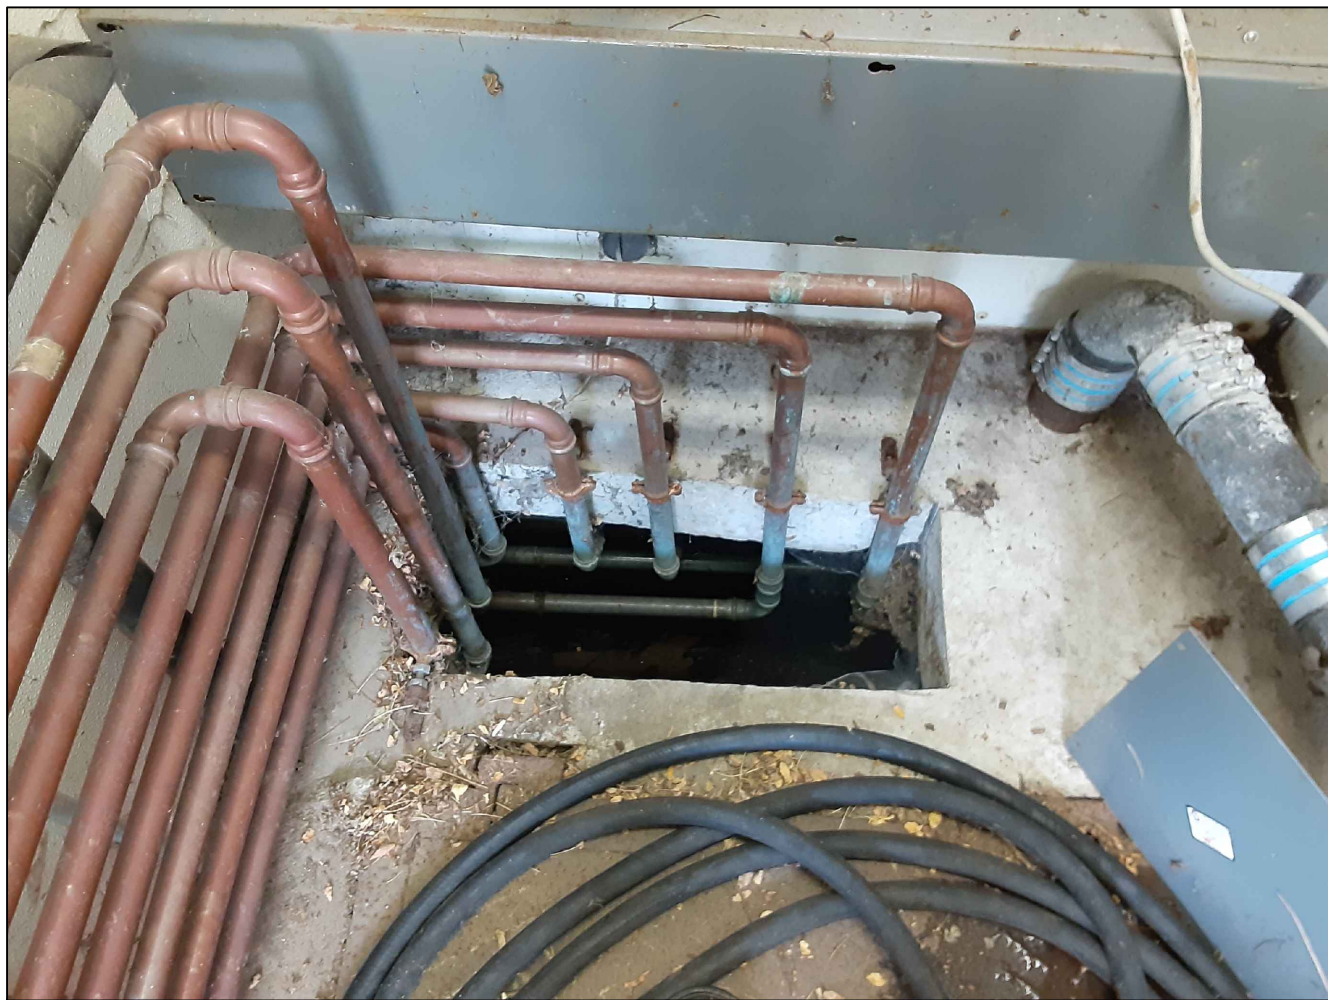

EXISTING 8 WATER SERVICES TO SPRAY
PARK FEATURES (EXITING BUILDING)

REV. NO.	DATE	DRWN	CHKD	REMARKS


DESIGNED BY: H. SULLIVAN
DRAWN BY: H. SULLIVAN
SHEET CHK'D BY: G. HOWARD
CROSS CHK'D BY: K. JOHNSTON
APPROVED BY: H. SULLIVAN
DATE: FEBRUARY 2023

**CDM
Smith**
75 State Street
Boston, MA 02109
Tel: (617) 452-6000


CITY OF WATERTOWN, MA
FILIPPELLO PARK SPRAY PAD RENOVATION

EXISTING UTILITY IMAGES


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FILE NAME: C007STPL.dwg
SHEET NO.
C-7

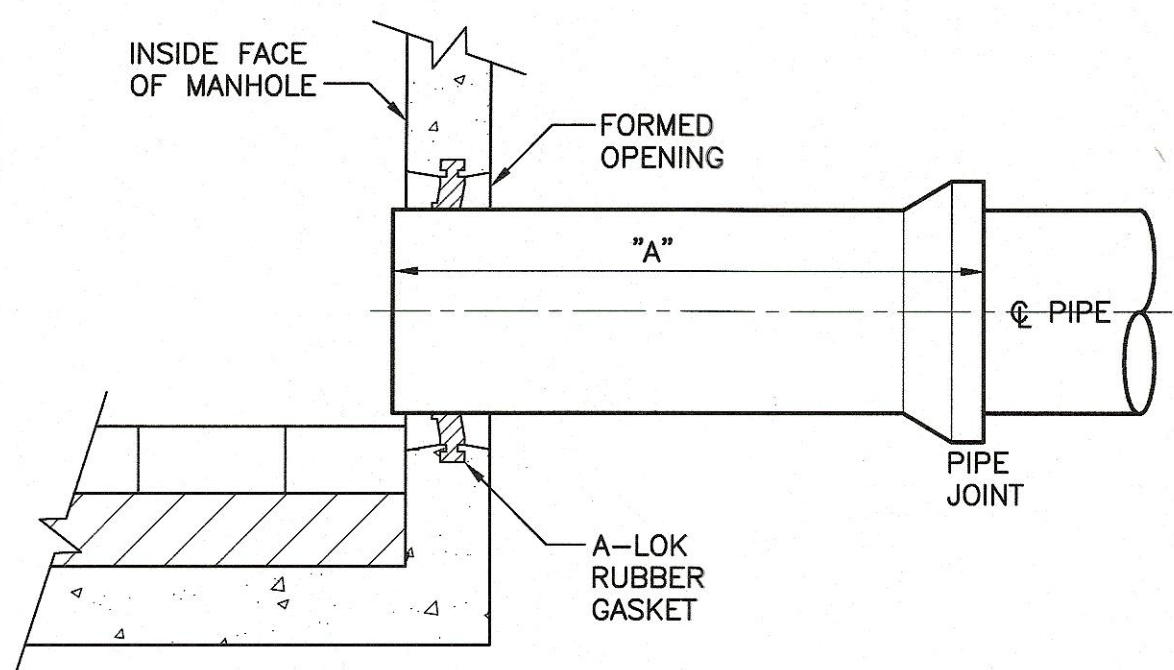


A-LOK SYSTEM

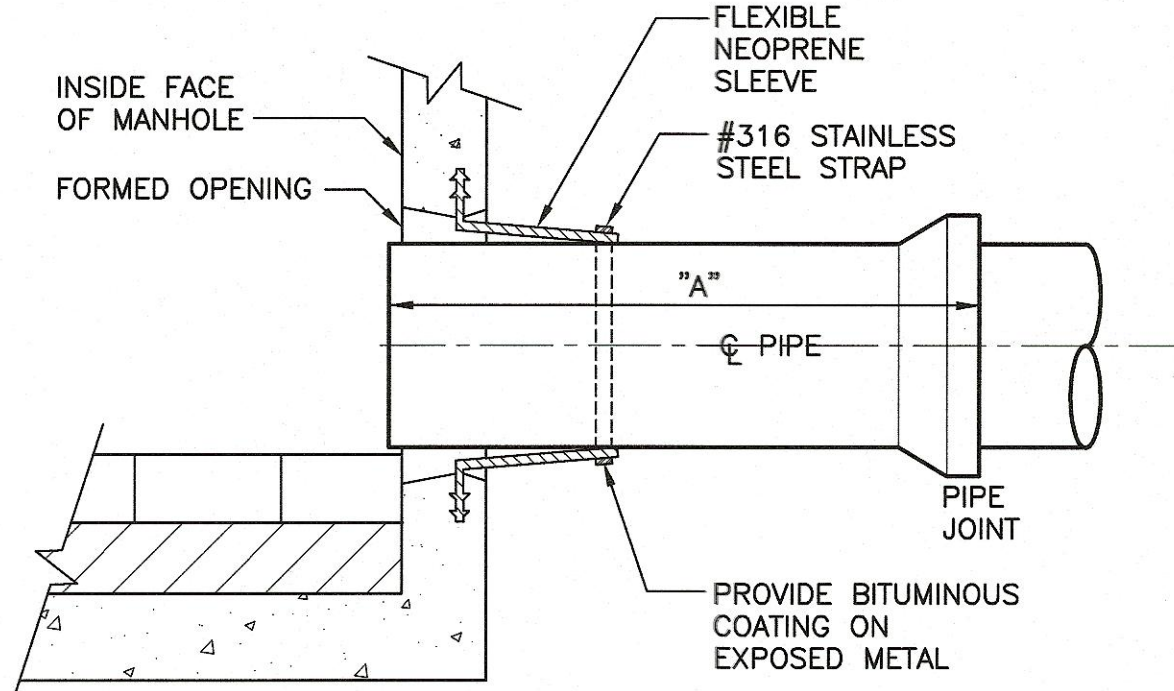

FLEXIBLE SLEEVE

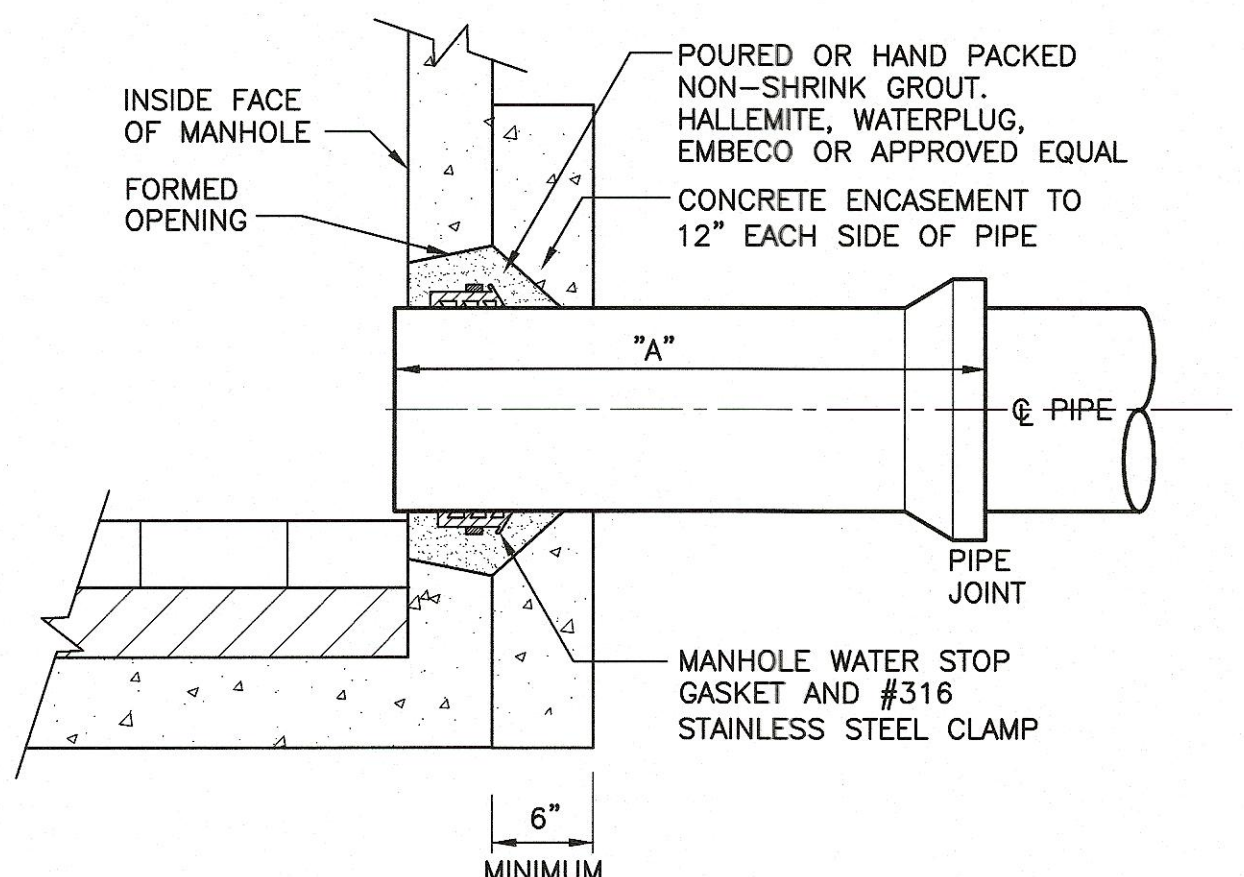


CONCRETE ENCASEMENT

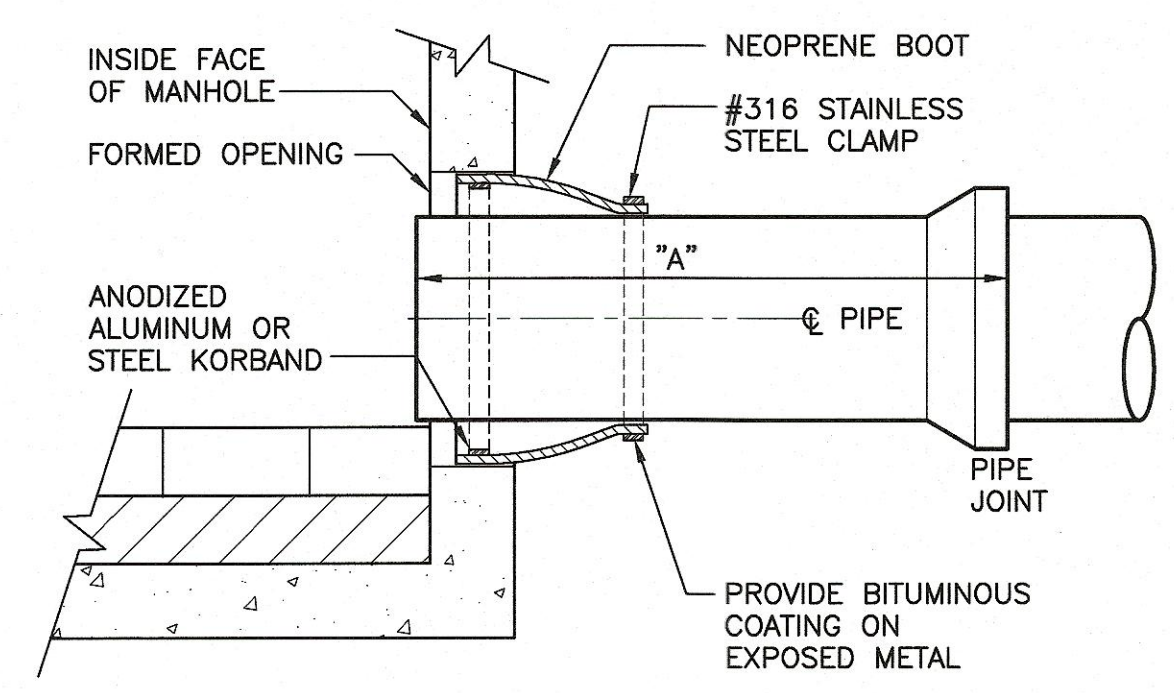


KOR-N-SEAL BOOT

PIPE CONNECTION DETAILS
DETAIL A
NOT TO SCALE


MAXIMUM STUB LENGTH	
PIPE MATERIAL	"A" (MAX.)
RC	4'-0"
PVC	3'-3"
DI	4'-6"

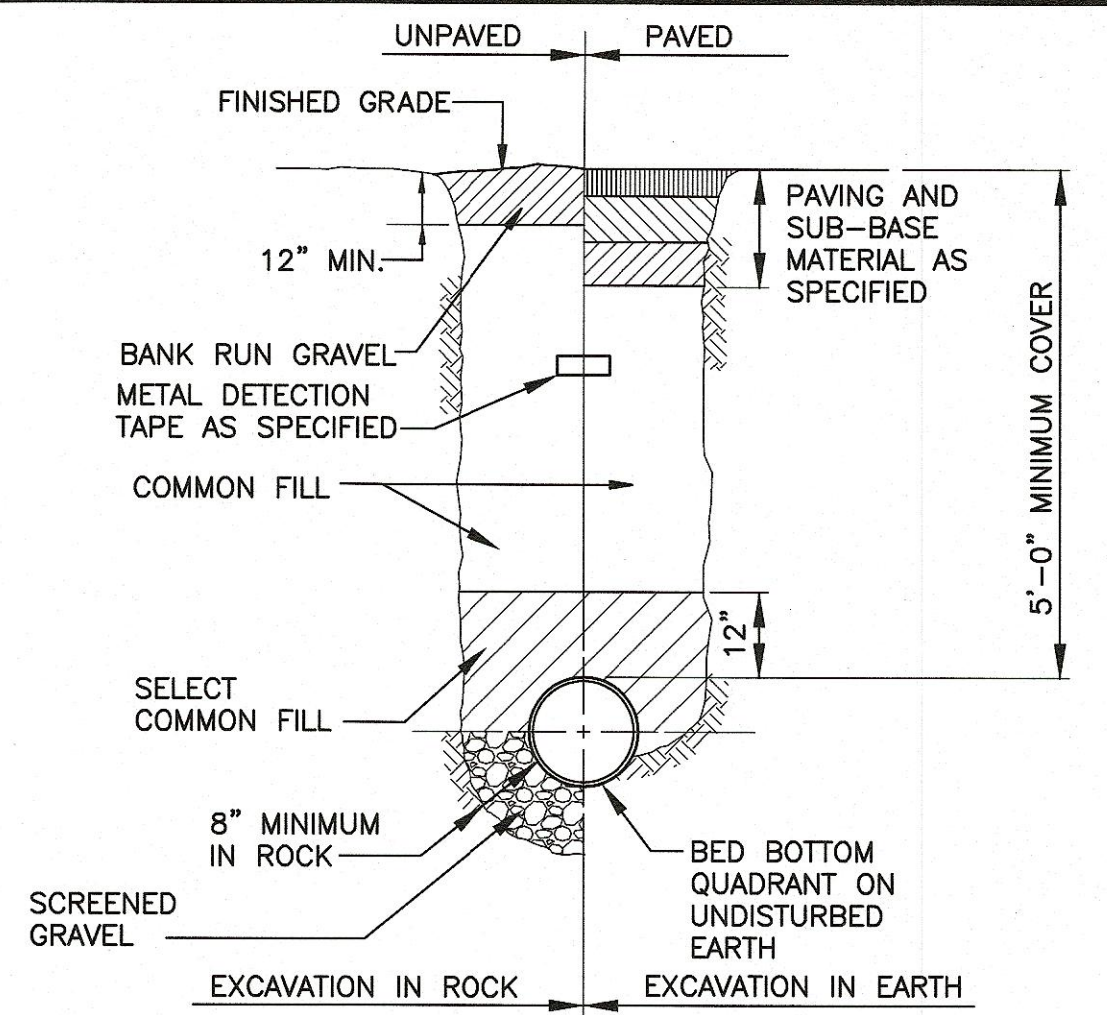


TYPICAL TRENCH DETAIL FOR WATER MAIN
DETAIL B
NOT TO SCALE

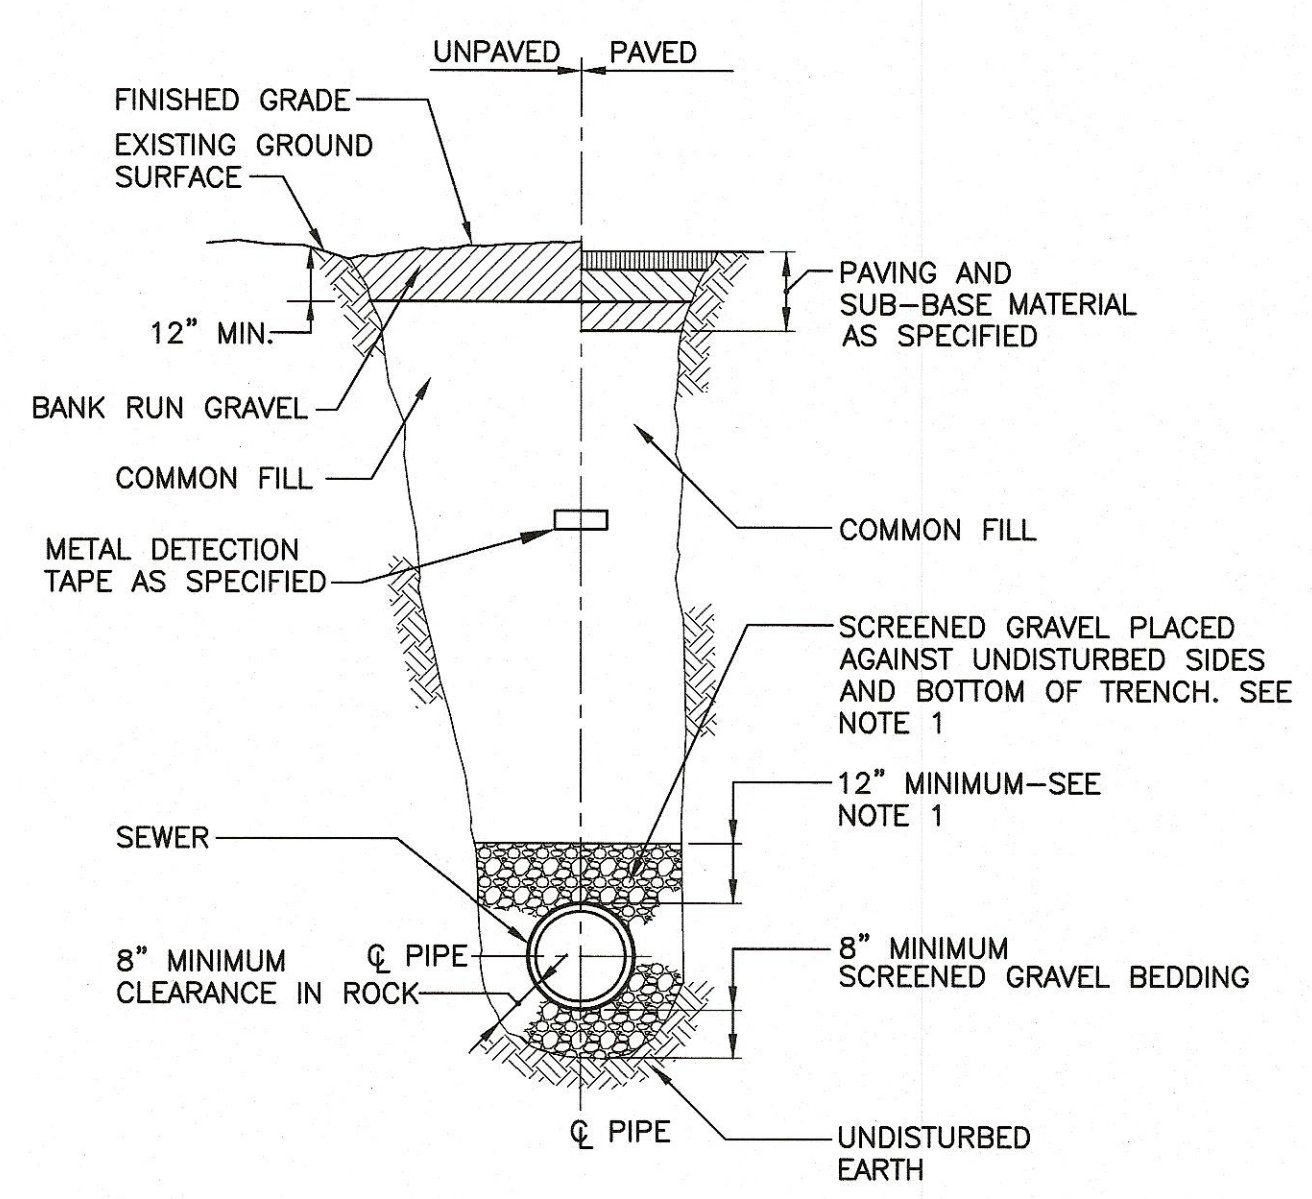


TYPICAL TRENCH DETAIL FOR SEWER & DRAIN PIPE
DETAIL C
NOT TO SCALE

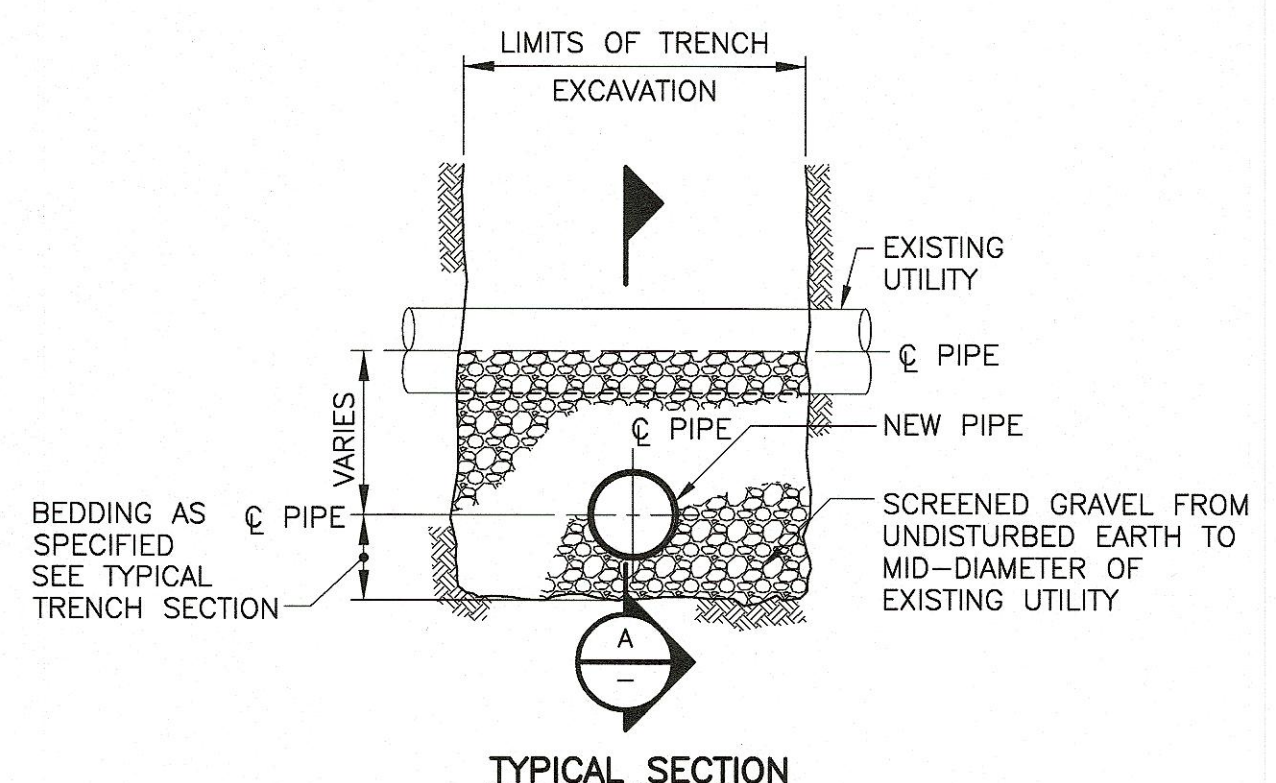


EXISTING UTILITY CROSSING
DETAIL D
NOT TO SCALE

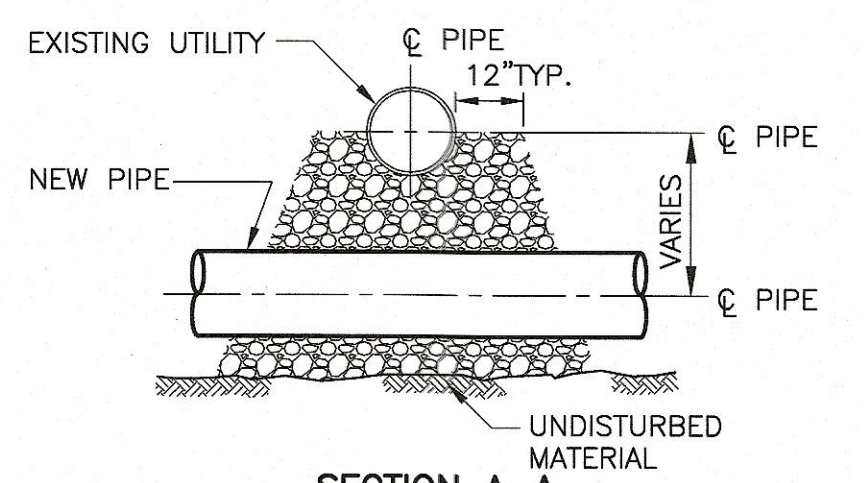

SECTION A-A

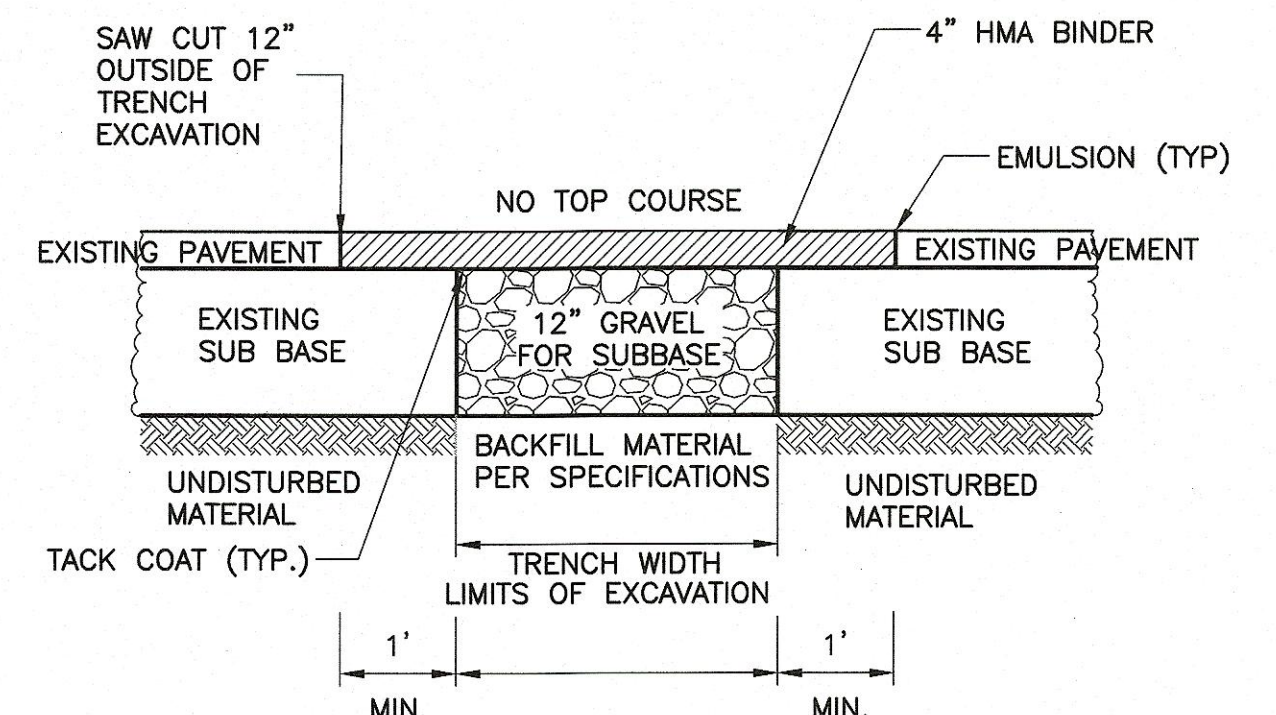


INITIAL TRENCH PAVING
DETAIL E
NOT TO SCALE

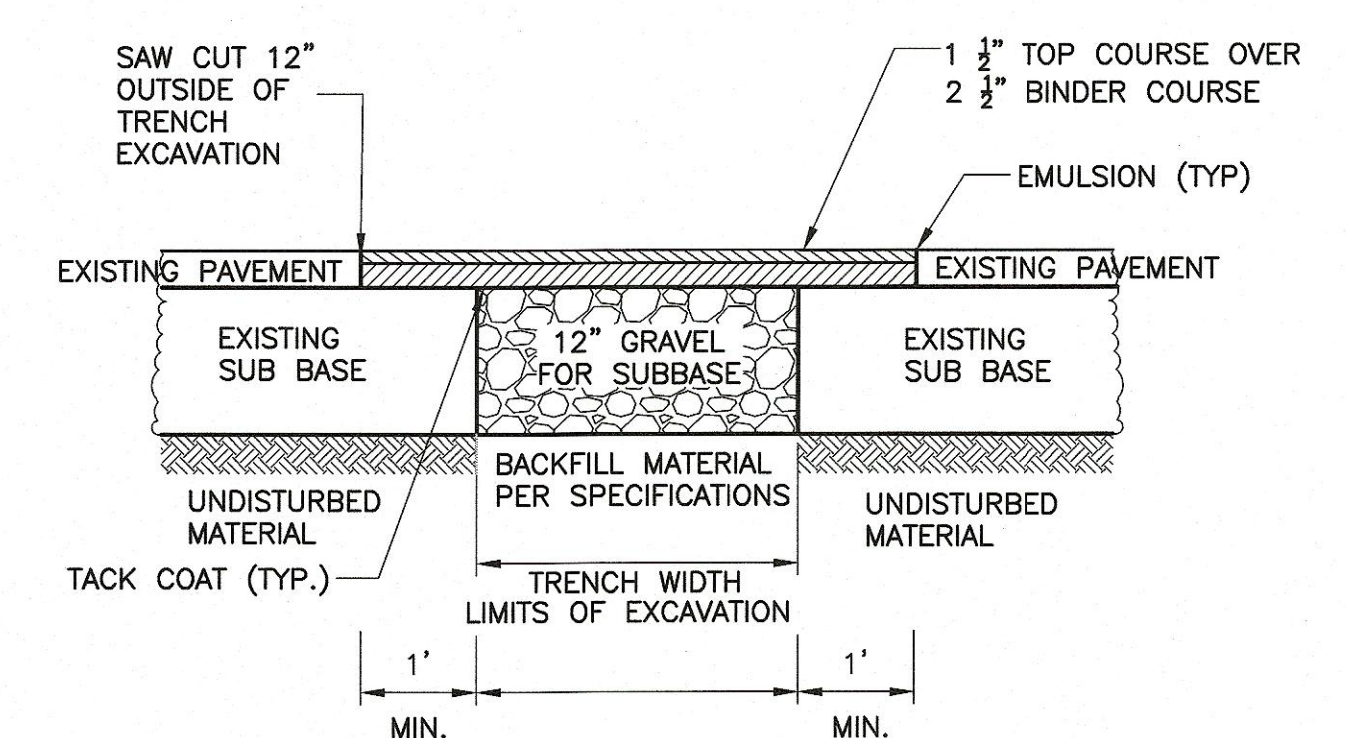

FINAL TRENCH PAVING
DETAIL F
NOT TO SCALE

- NOTES:
1. THE CONTRACTOR SHALL MAINTAIN INITIAL PAVING FOR A MINIMUM OF 90 DAYS AND UNTIL FINAL PAVING IS PERFORMED.
 2. IF INITIAL PAVING IS PLACED AFTER OCTOBER 1ST, THEN IT SHALL BE MAINTAINED UNTIL PERMANENT PAVING IS PLACED.
 3. CONTRACTOR SHALL MATCH EXISTING ROADWAY GRADES.

- NOTES:
1. THE CONTRACTOR SHALL MAINTAIN INITIAL PAVING UNTIL FINAL PAVING IS PERFORMED.
 2. CONTRACTOR SHALL MATCH EXISTING ROADWAY GRADES.
 3. CONTRACTOR SHALL REMOVE INITIAL PAVING, REGRADE SUBBASE AND INSTALL FINAL PAVING.
 4. PERMANENT PAVING SHALL ONLY BE PLACED BETWEEN MAY 15 AND SEPTEMBER 30.

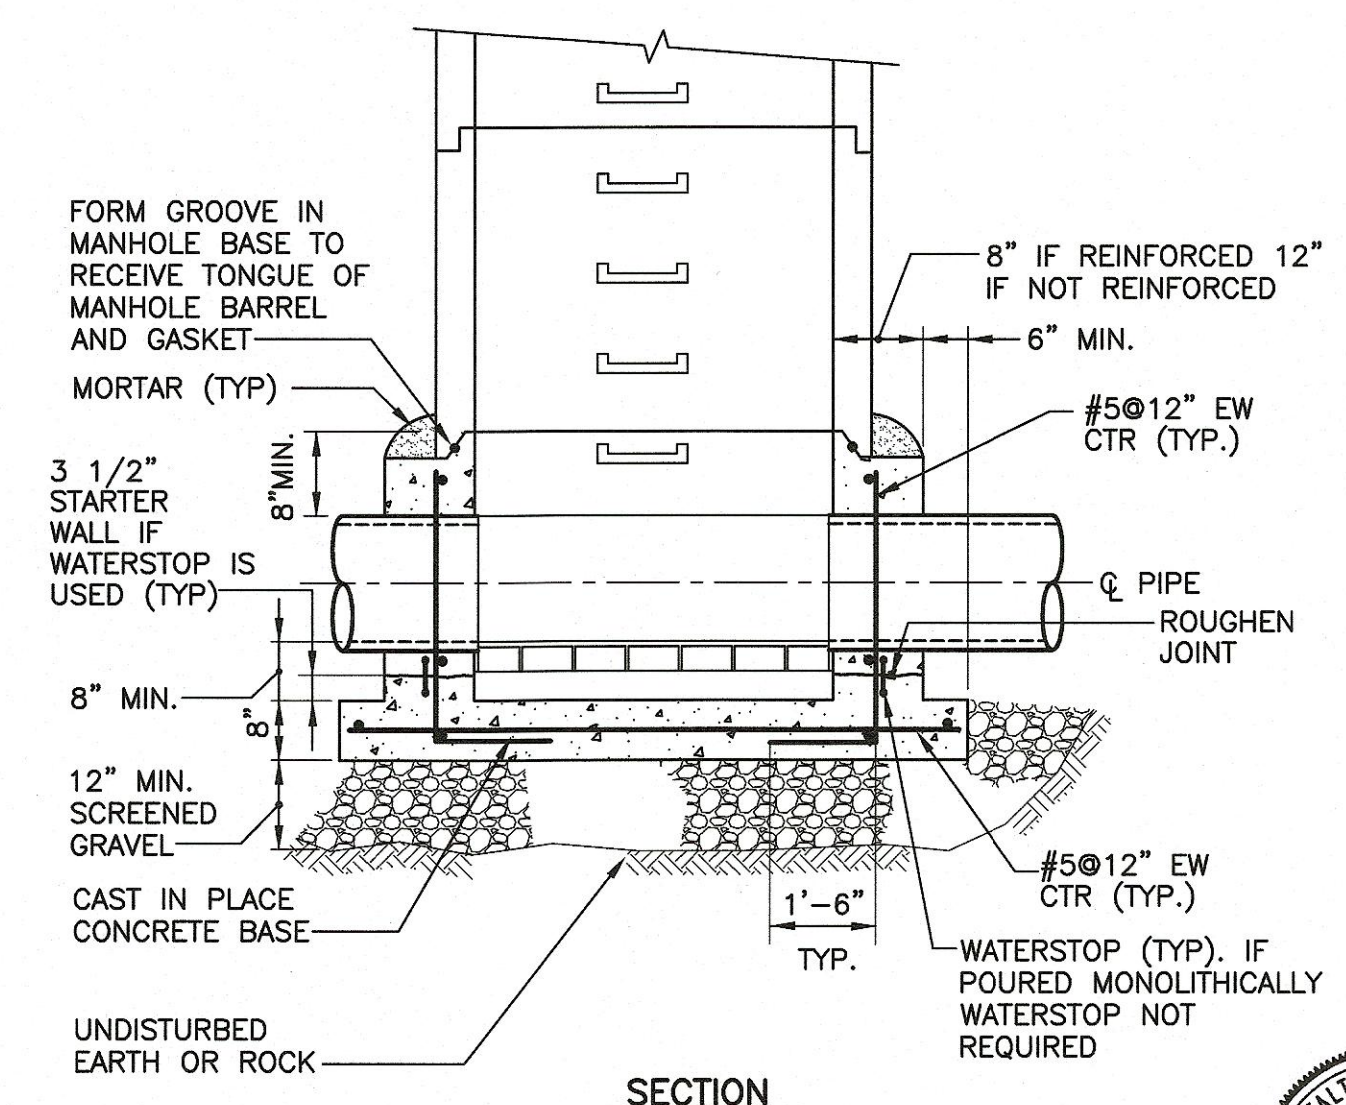

TYPICAL PRECAST MANHOLE WITH CAST-IN-PLACE BASE
DETAIL G
NOT TO SCALE



2-7-2023

XREFs: [CDMS 2436] Images: []
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p:\cdm\smith-h-a202-pv-bentley.com\p\156318\267753\04 Design Services NM_60\102 Chv10 BIM_CADD\001\STPL.dwg
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REV.	DATE	DRWN	CHKD	REMARKS

DESIGNED BY: G. HOWARD
DRAWN BY: H. SULLIVAN
SHEET CHK'D BY: G. HOWARD
CROSS CHK'D BY: S. LANDGREN
APPROVED BY: H. SULLIVAN
DATE: FEBRUARY 2023


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Boston, MA 02109
Tel: (617) 452-8000

CITY OF WATERTOWN, MA
FILIPPELLO PARK SPRAY PAD RENOVATION


CIVIL DETAILS I

PROJECT NO. 56318-267753
FILE NAME: D001STPL.DWG
SHEET NO.
D-1


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- NOTES:
1. STAKES SHALL NOT EXTEND ABOVE THE COMPOST SOCK MORE THAN 2".
 2. ENDS OF COMPOST SOCK SHALL BE TURNED SLIGHTLY UPSLOPE.
 3. SILT SOCK SHALL BE FILTREXXSM SILT SOCKSM NATURAL ORIGINALSM (BIODEGRADABLE) OR APPROVED EQUAL.
 4. PROVIDE A DOUBLE ROW OF COMPOST SOCK WITHIN 50 FEET OF WATER BODY OR WETLAND.

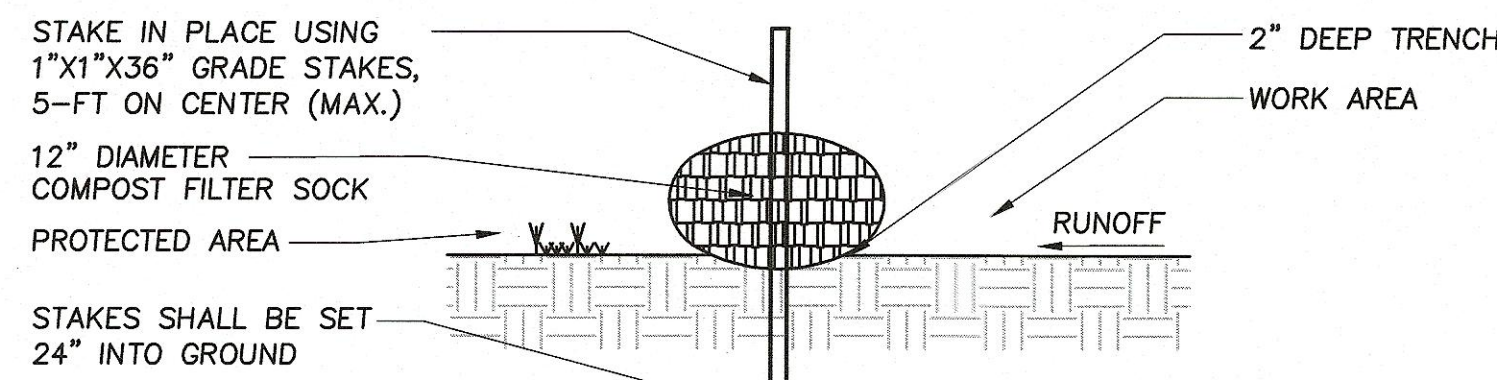


COMPOST FILTER SOCK
DETAIL A
NOT TO SCALE

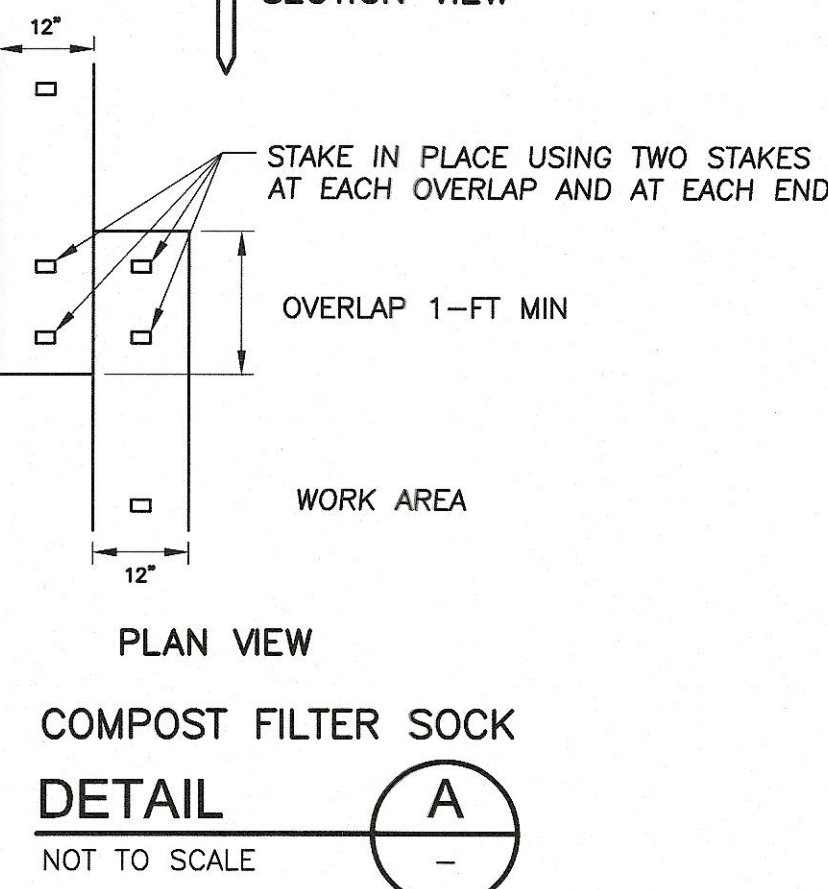


- NOTES:
1. BASE COURSE SHALL EXTEND 3" MIN. BEYOND EDGE OF PAVEMENT.
 2. CONTRACTOR MAY UTILIZE EXISTING GRANULAR BASE WHERE NEW PAVEMENT IS SHOWN OVER EXISTING.

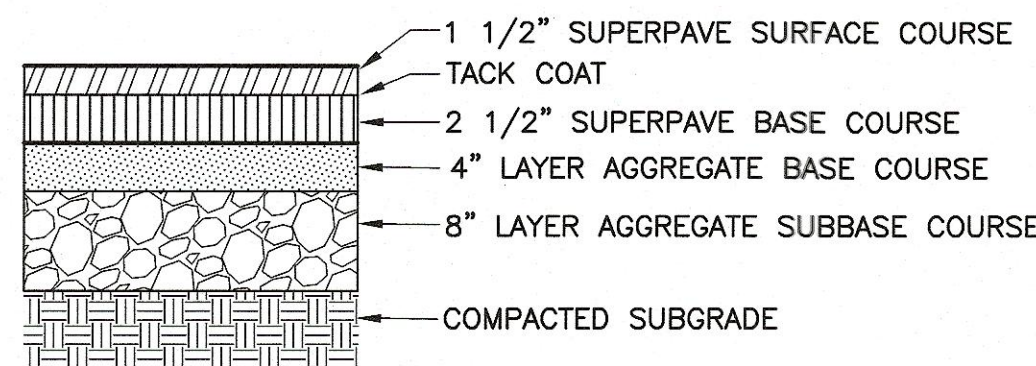BITUMINOUS CONCRETE PAVEMENT

DETAIL B
NOT TO SCALE

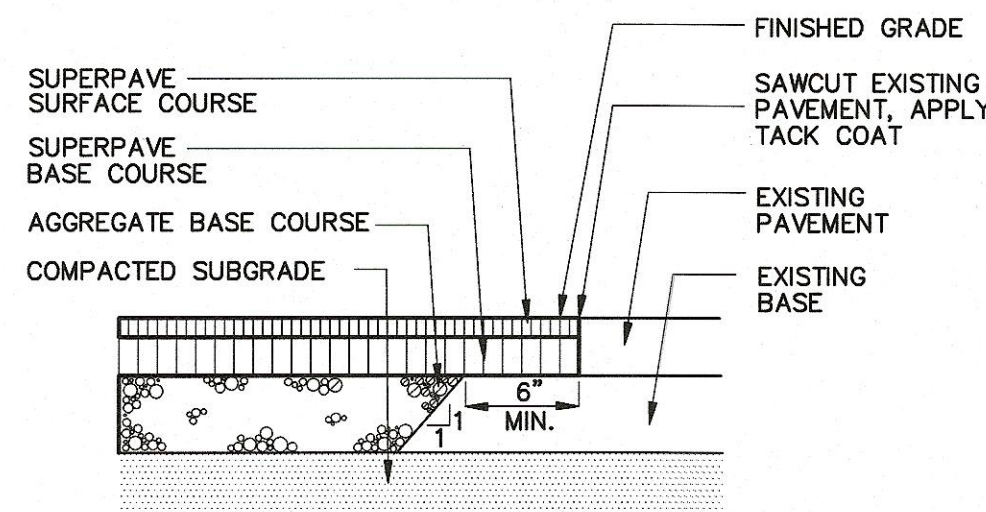


PAVEMENT MATCH
DETAIL C
NOT TO SCALE

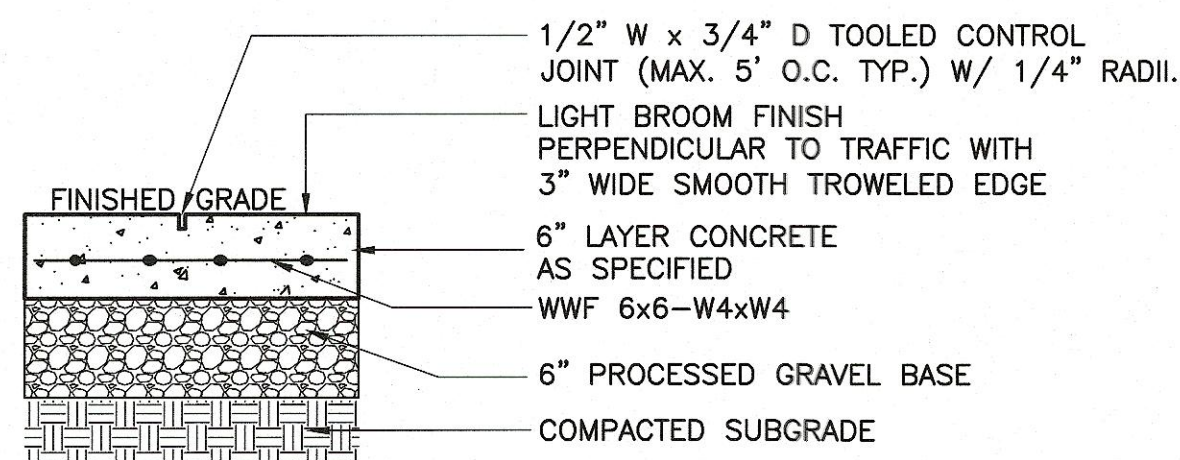


CONCRETE PAD
DETAIL D
NOT TO SCALE

TOP VIEW

ELEVATION VIEW

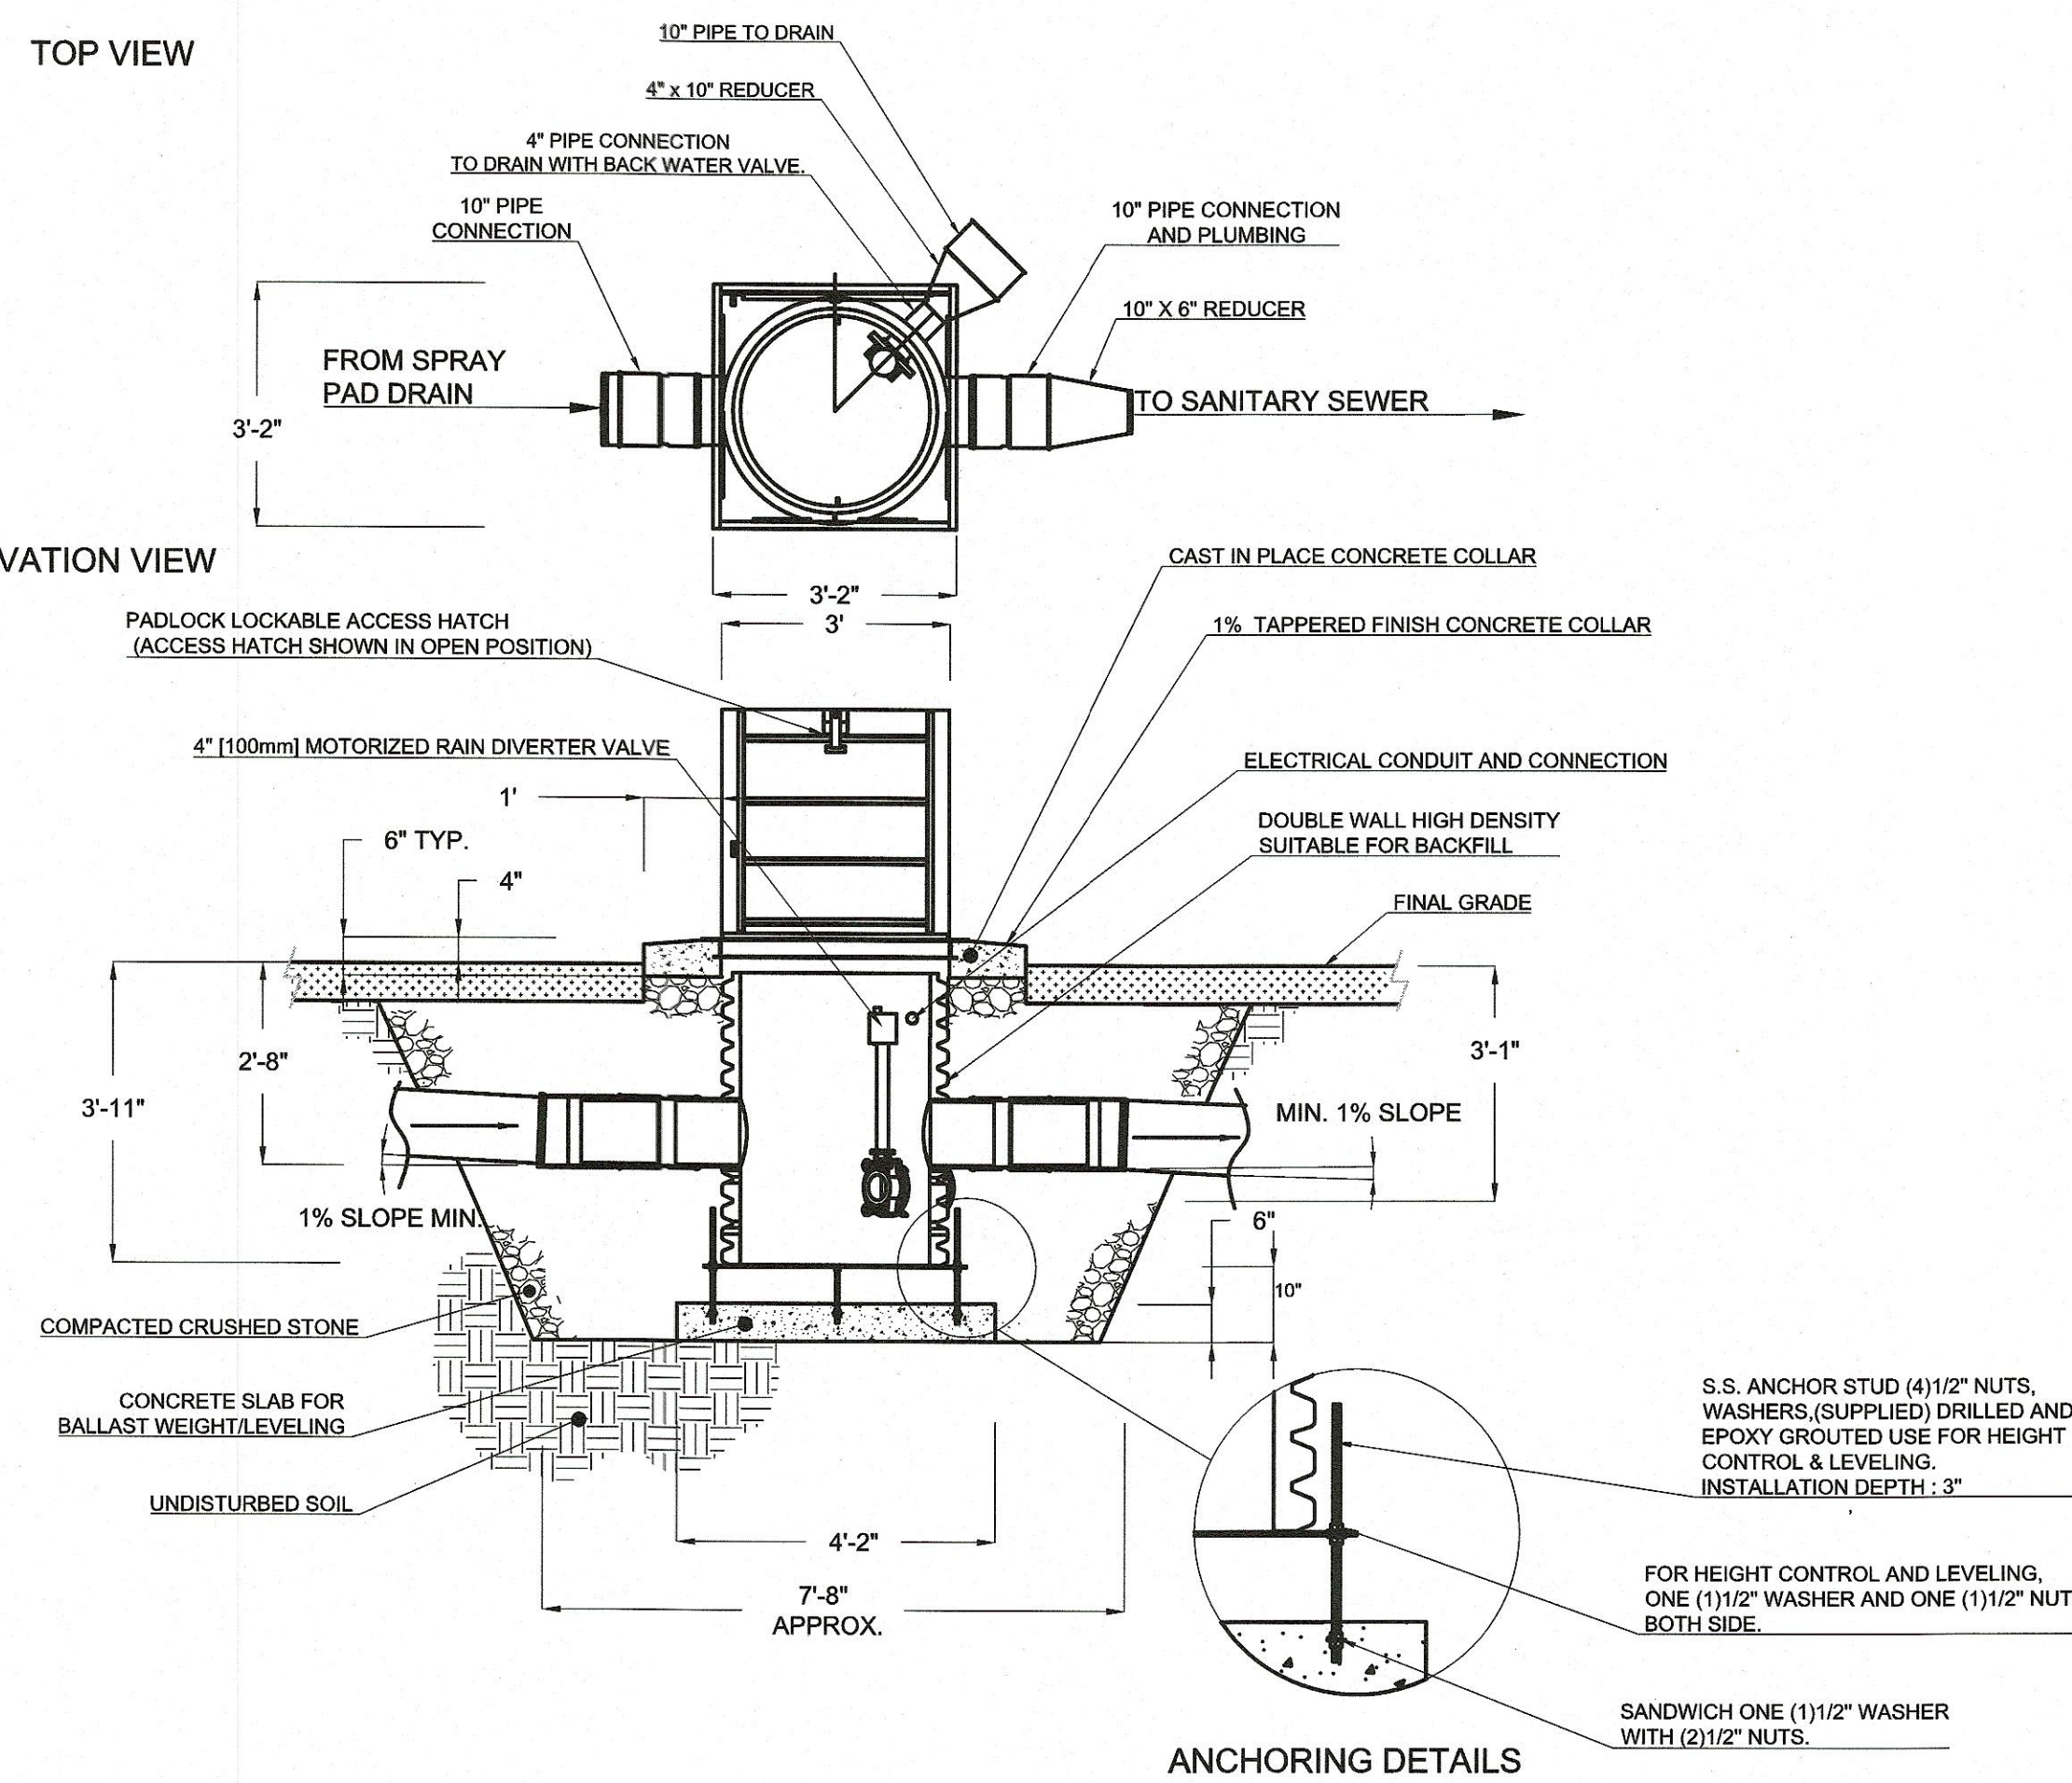

HDPE WITH RAIN DIVERTER MANHOLE
DETAIL E
NOT TO SCALE

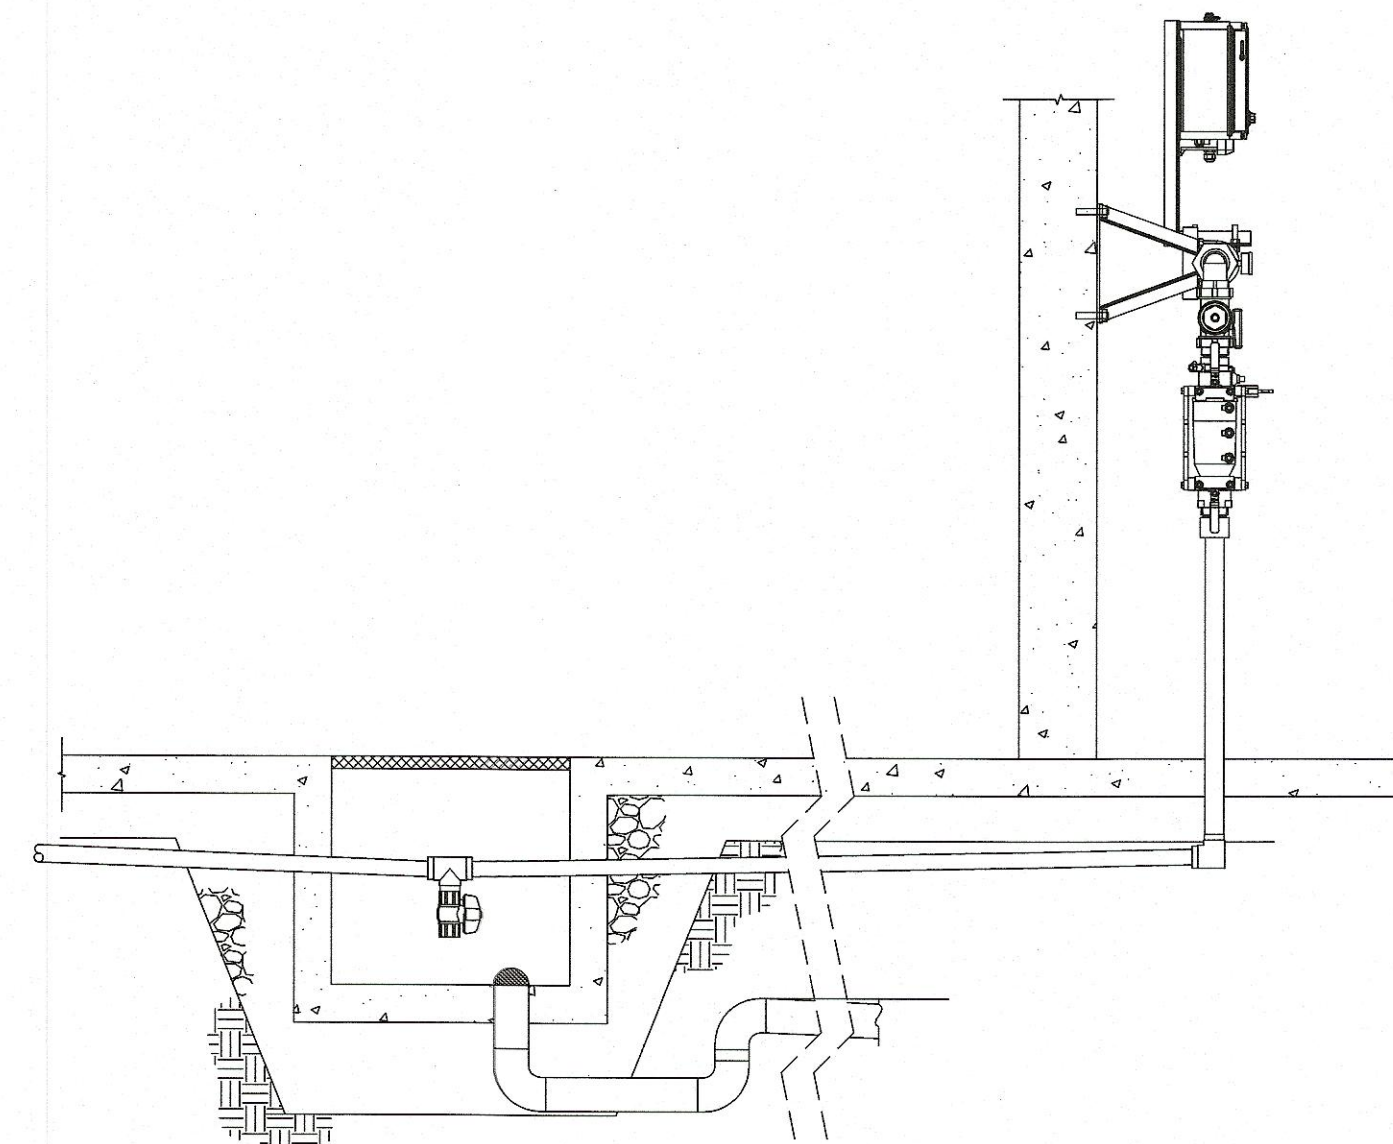

WALL MOUNTED MANIFOLD AND CONTROL CENTER
DETAIL F
NOT TO SCALE



2-7-2023



REV.	DATE	DRWN	CHKD	REMARKS


DESIGNED BY:	G. HOWARD
DRAWN BY:	H. SULLIVAN
SHEET CHK'D BY:	G. HOWARD
CROSS CHK'D BY:	S. LANDGREN
APPROVED BY:	H. SULLIVAN
DATE:	FEBRUARY 2023

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Boston, MA 02109
Tel: (617) 452-6000

CITY OF WATERTOWN, MA
FILIPPELLO PARK SPRAY PAD RENOVATION


SPRAY PAD DETAILS I

PROJECT NO. 56318-267753
FILE NAME: CD02STD.T.dwg
SHEET NO.
D-2

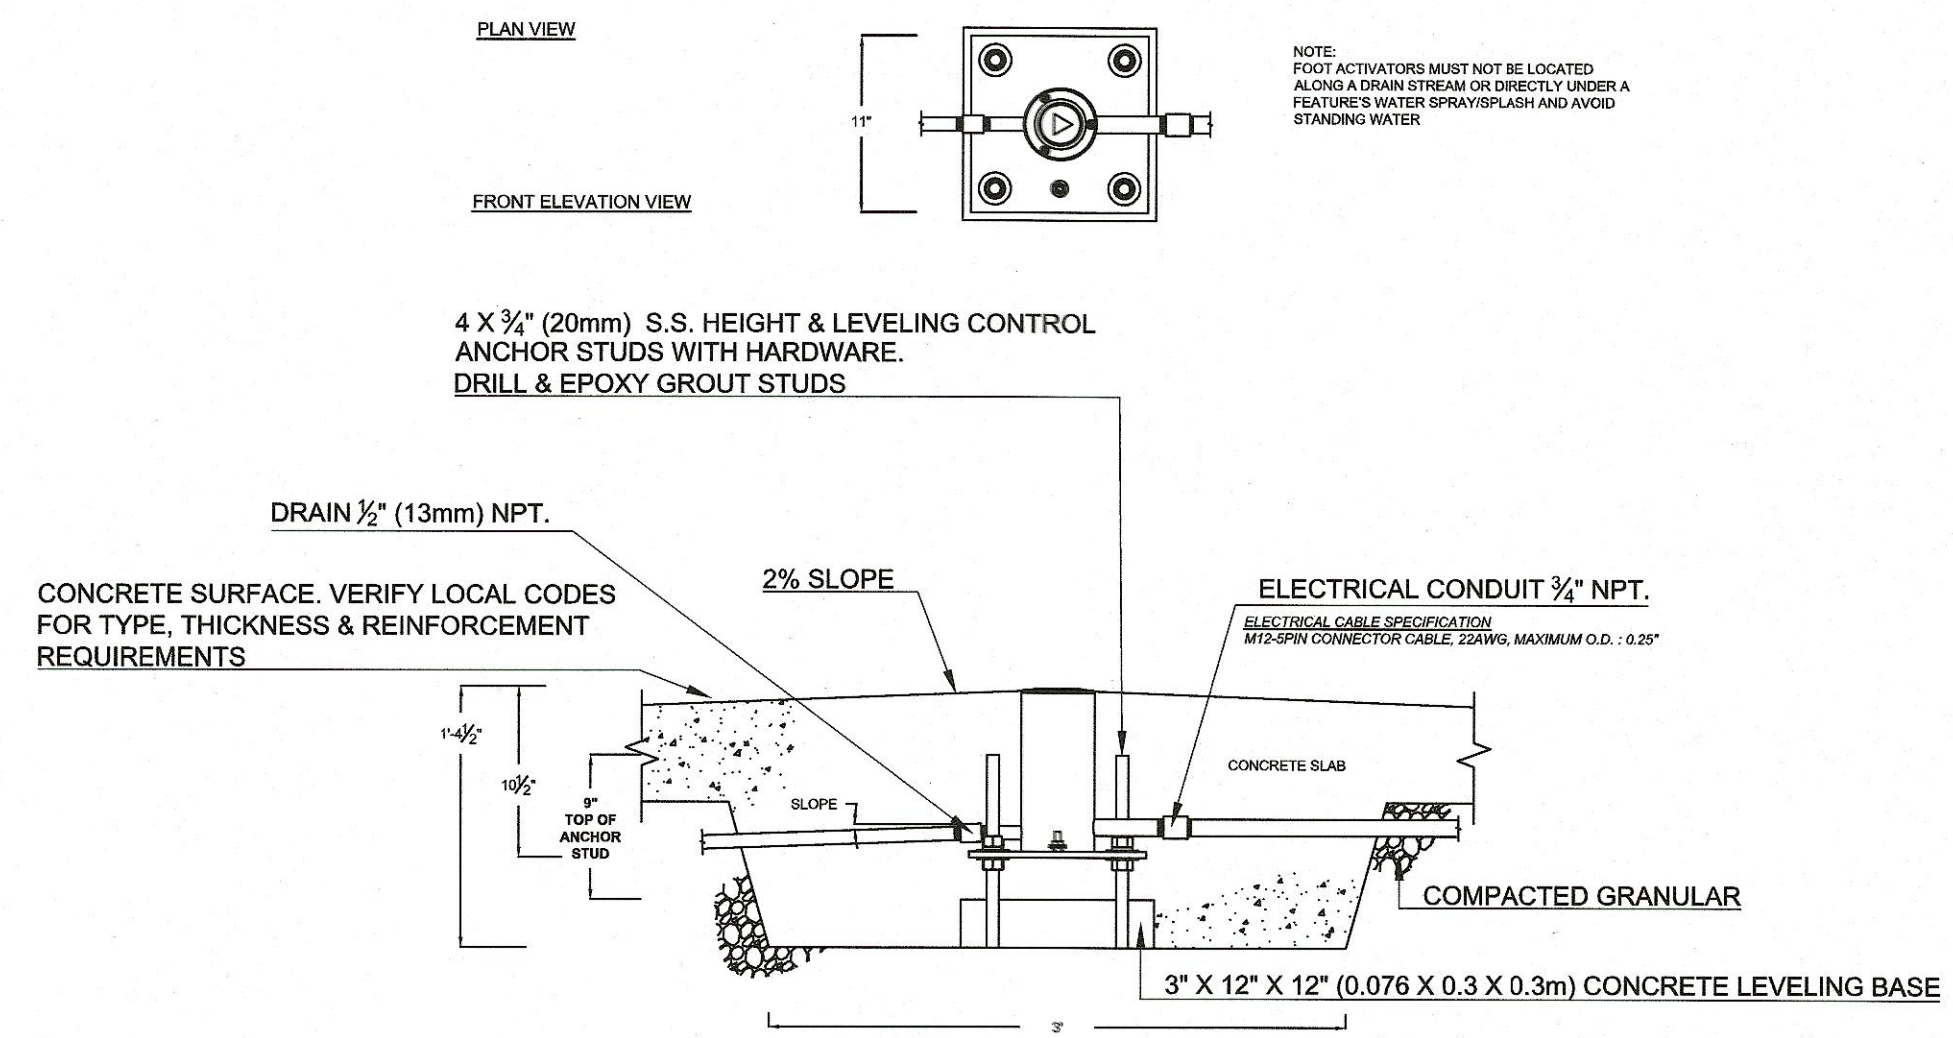
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DETAIL
NOT TO SCALE

A
D-3

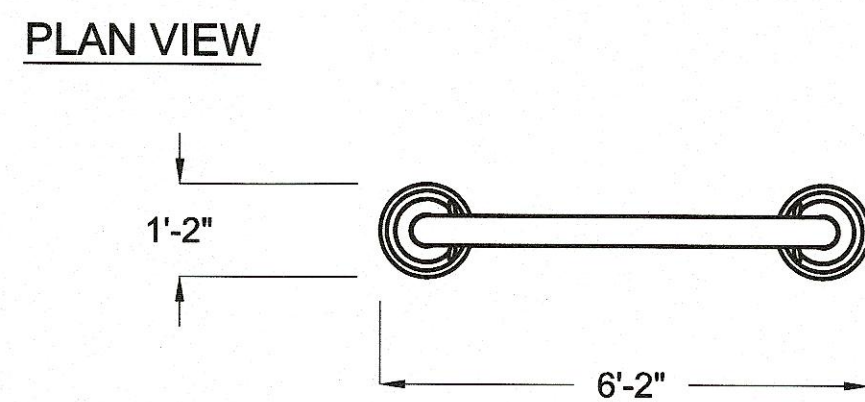

FRONT ELEVATION VIEW

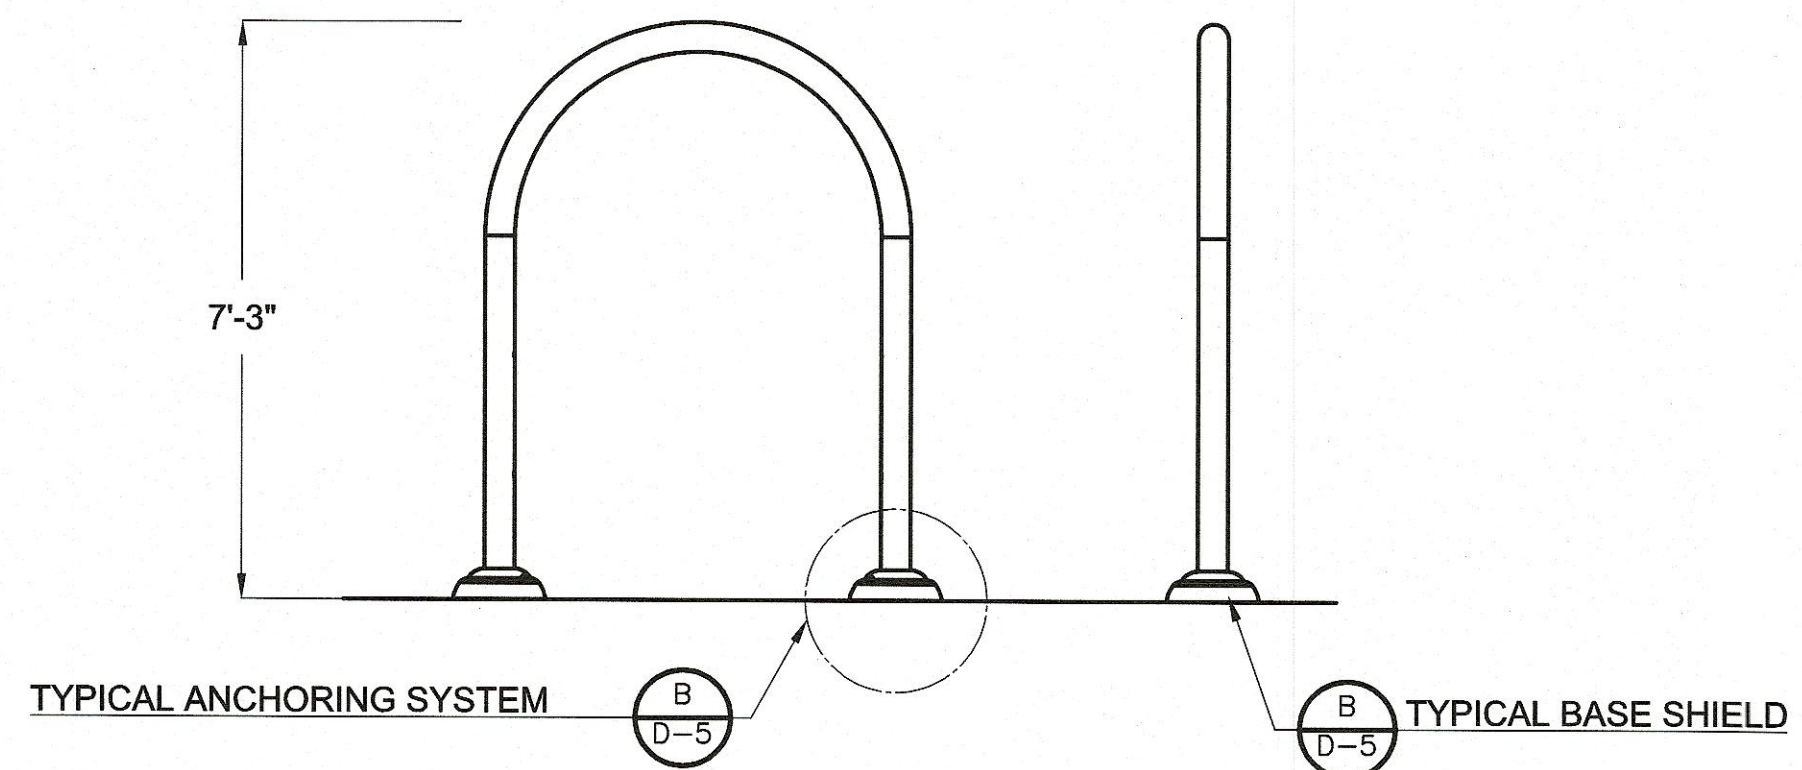


ARCH

DETAIL


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C

D-3

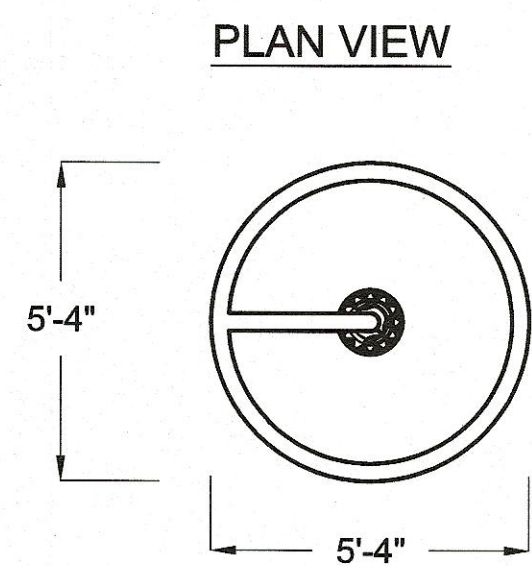


FRONT ELEVATION VIEW

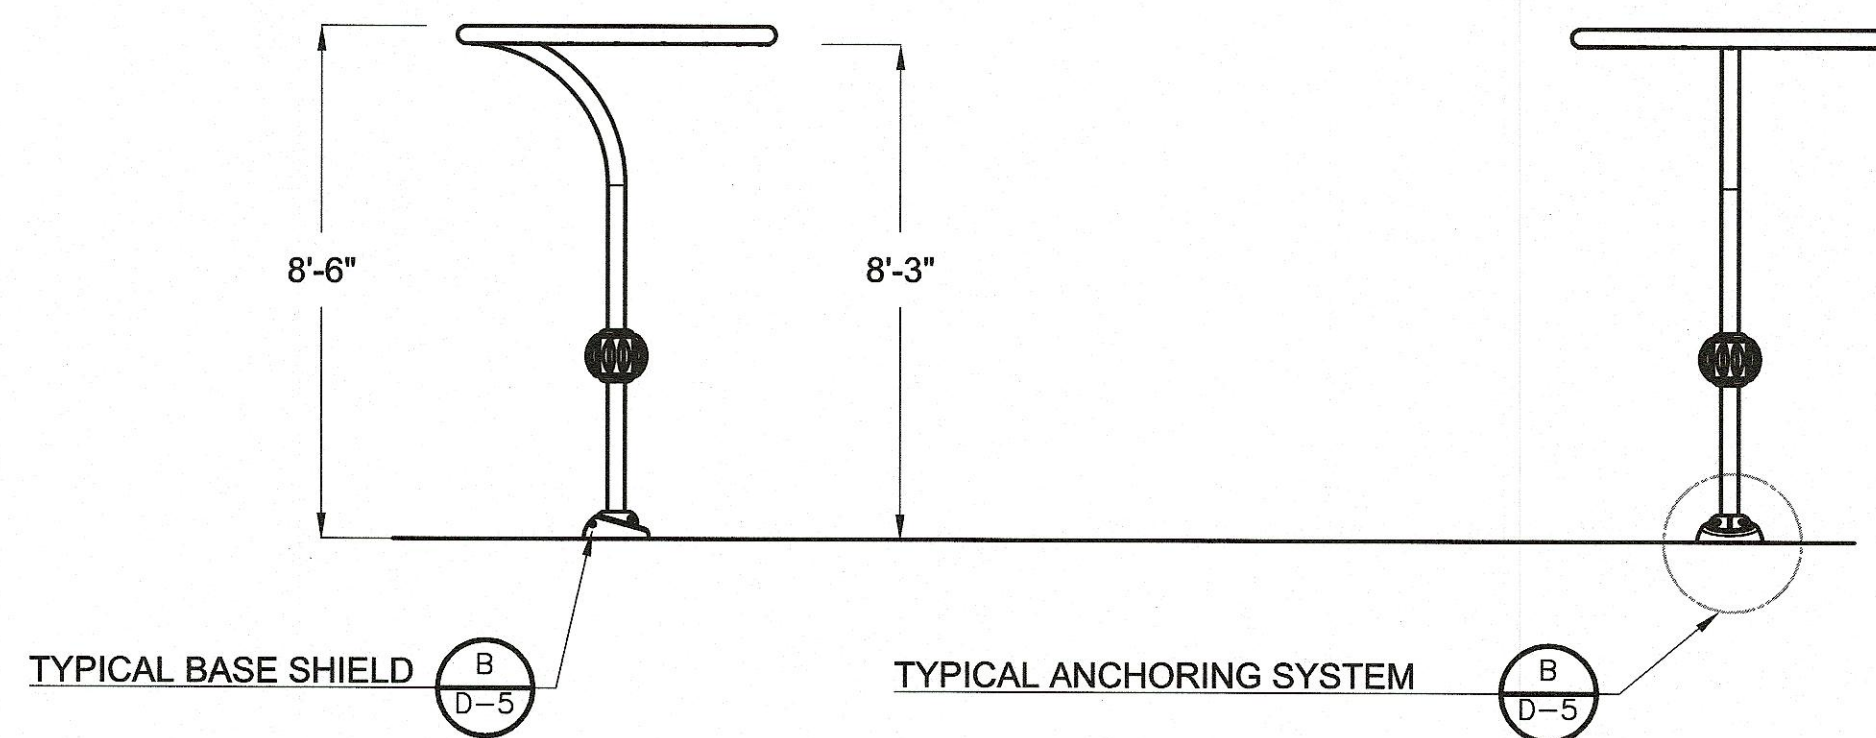


ASTRA NO.3

DETAIL D


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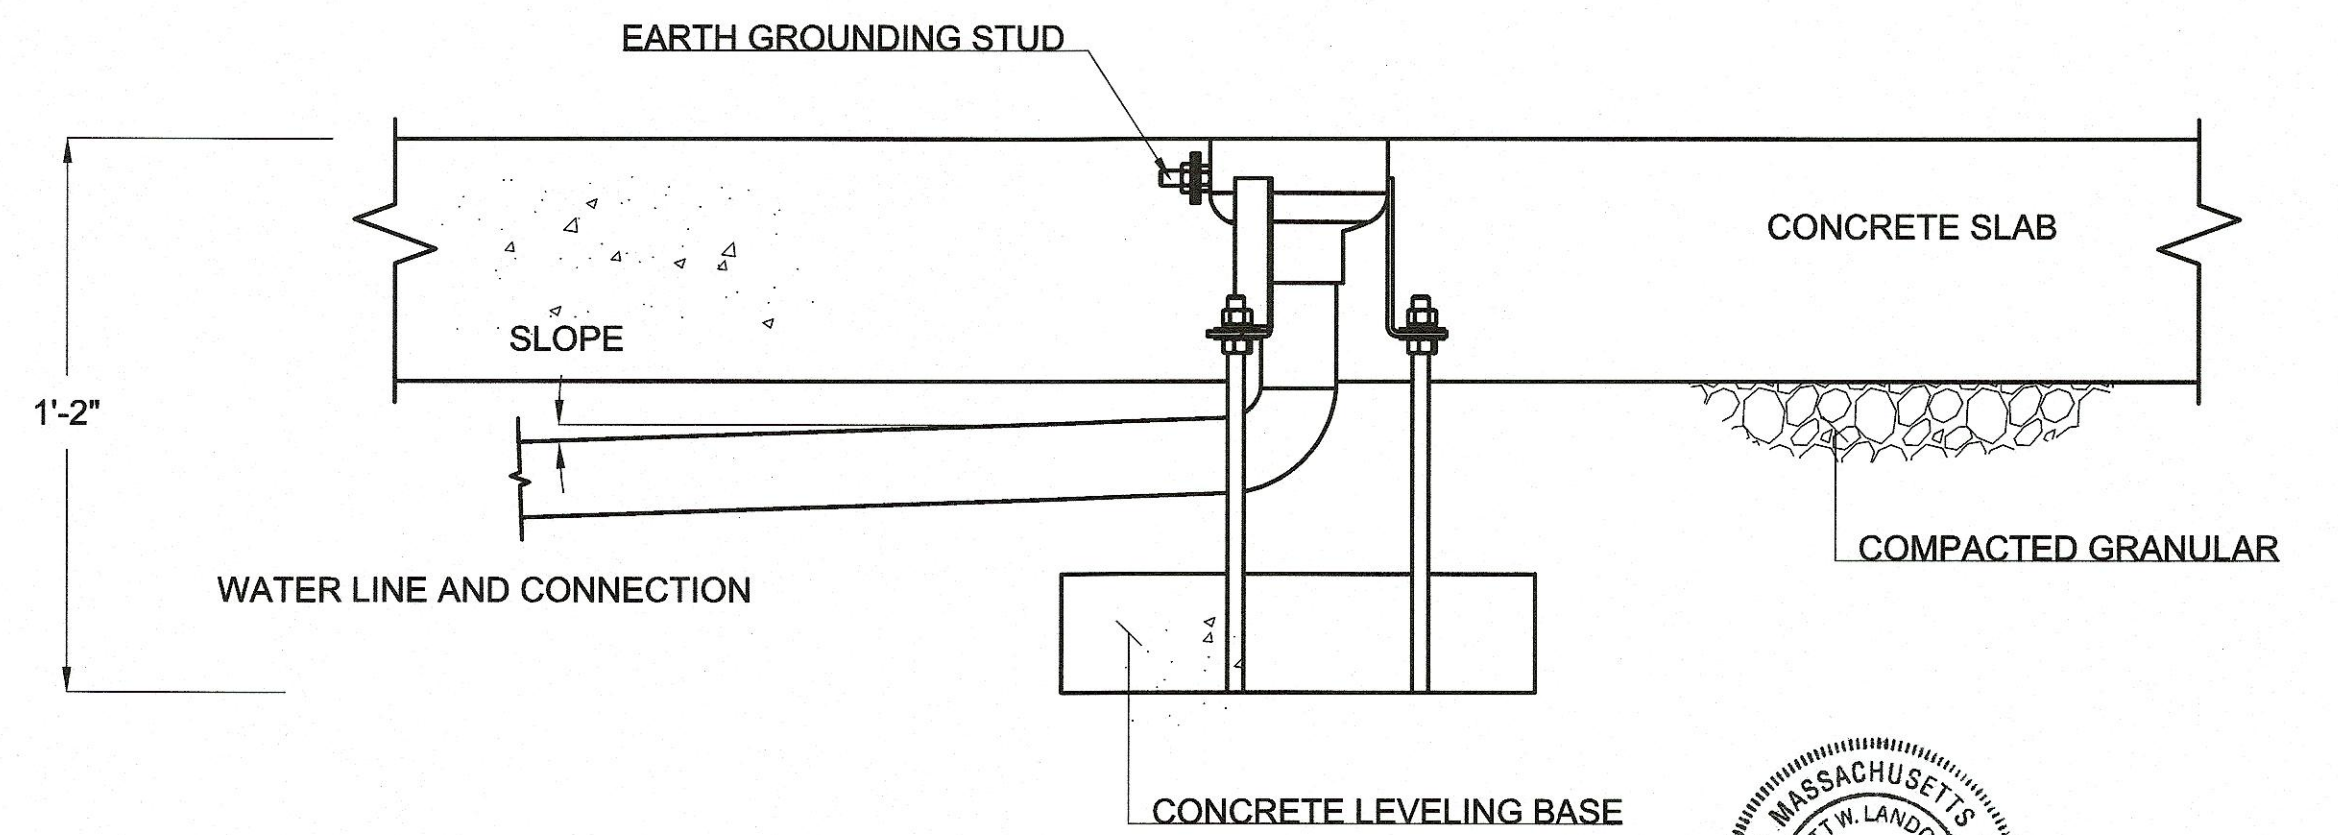
FRONT ELEVATION VIEW

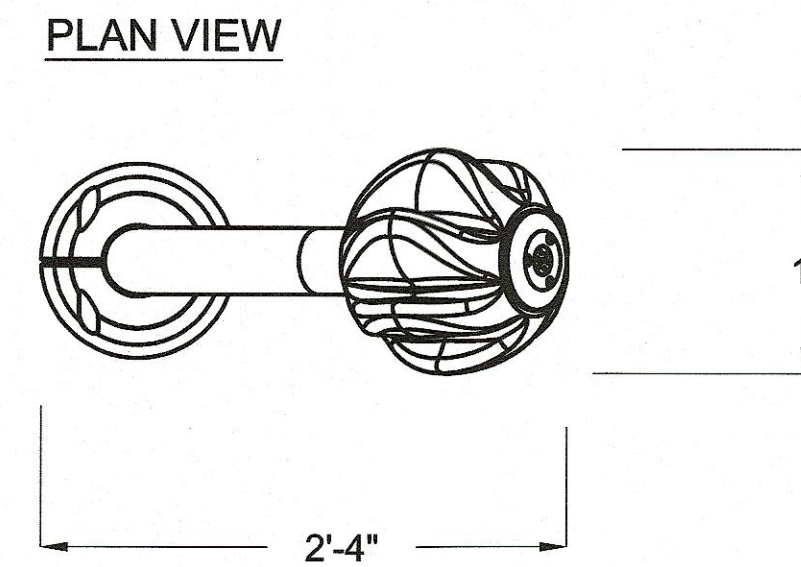

LUNA CANNON NO.1
DETAIL E
NOT TO SCALE D-3

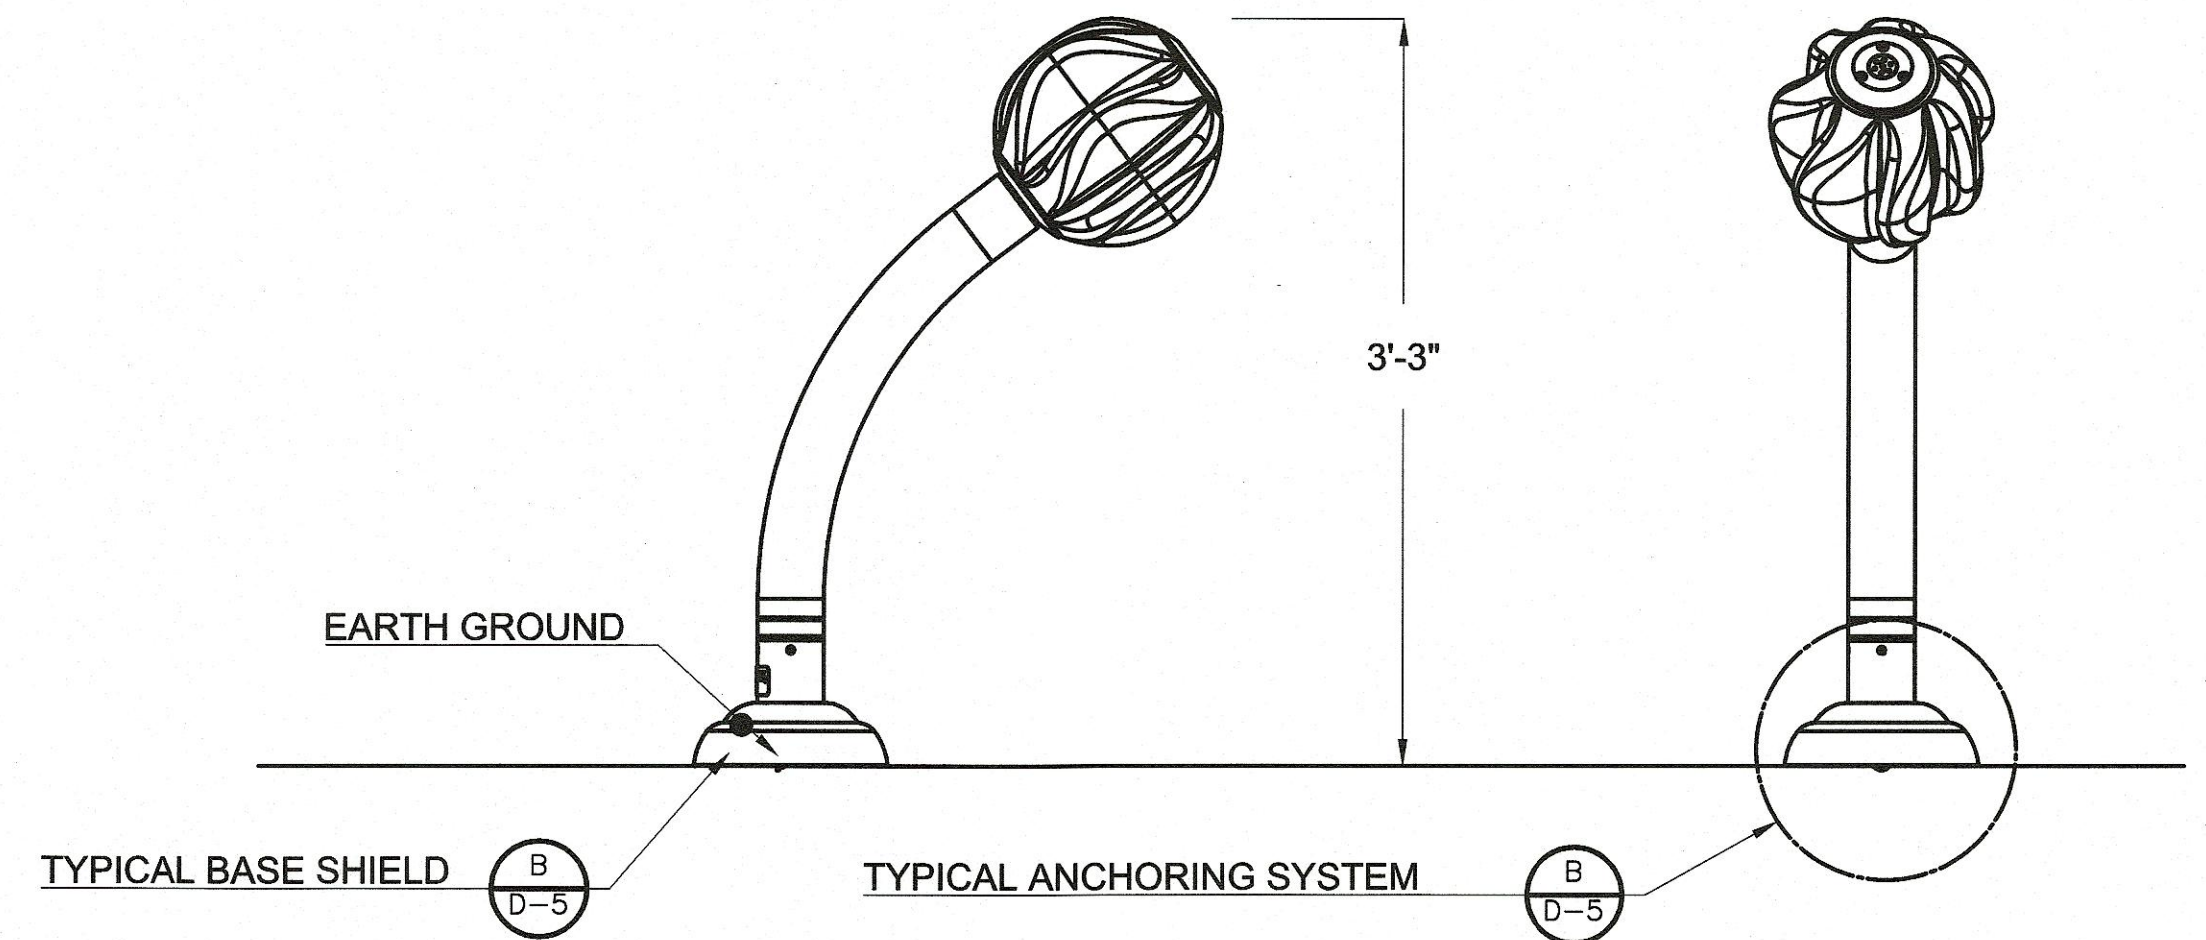

FRONT ELEVATION VIEW

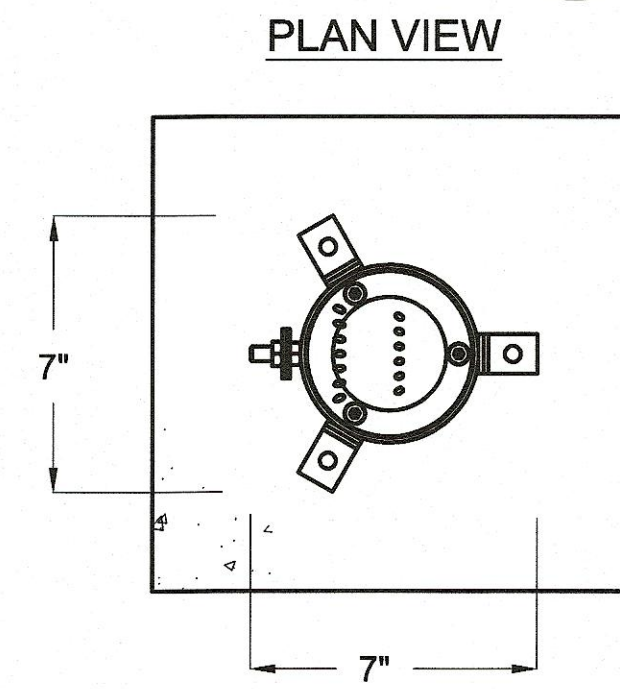

ROOSTER TAIL

DETAIL

NOT TO SCALE

F

D-3



REV. NO.	DATE	DRWN	CHKD	REMARKS

DESIGNED BY: G. HOWARD
DRAWN BY: J. BRONENKANT
SHEET CHK'D BY: G. HOWARD
CROSS CHK'D BY: S. LANDGREN
APPROVED BY: S. LANDGREN
DATE: FEBRUARY 2023



CITY OF WATERTOWN, MA

FILIPPELLO PARK SPRAY PAD RENOVATION


SPRAY PAD DETAILS II

PROJECT NO.	56318-267753
FILE NAME:	CD03STDT.dwg
SHEET NO.	



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NOTE:
"BY INSTALLER/BY CONTRACTOR "MAY REFER TO SERVICE PROVIDERS OTHER THAN THE EQUIPMENT MANUFACTURER. PLEASE REFER TO PROJECT SPECIFICATION FOR DETAILS OF RESPONSIBILITY.



GEYSER
DETAIL A
NOT TO SCALE

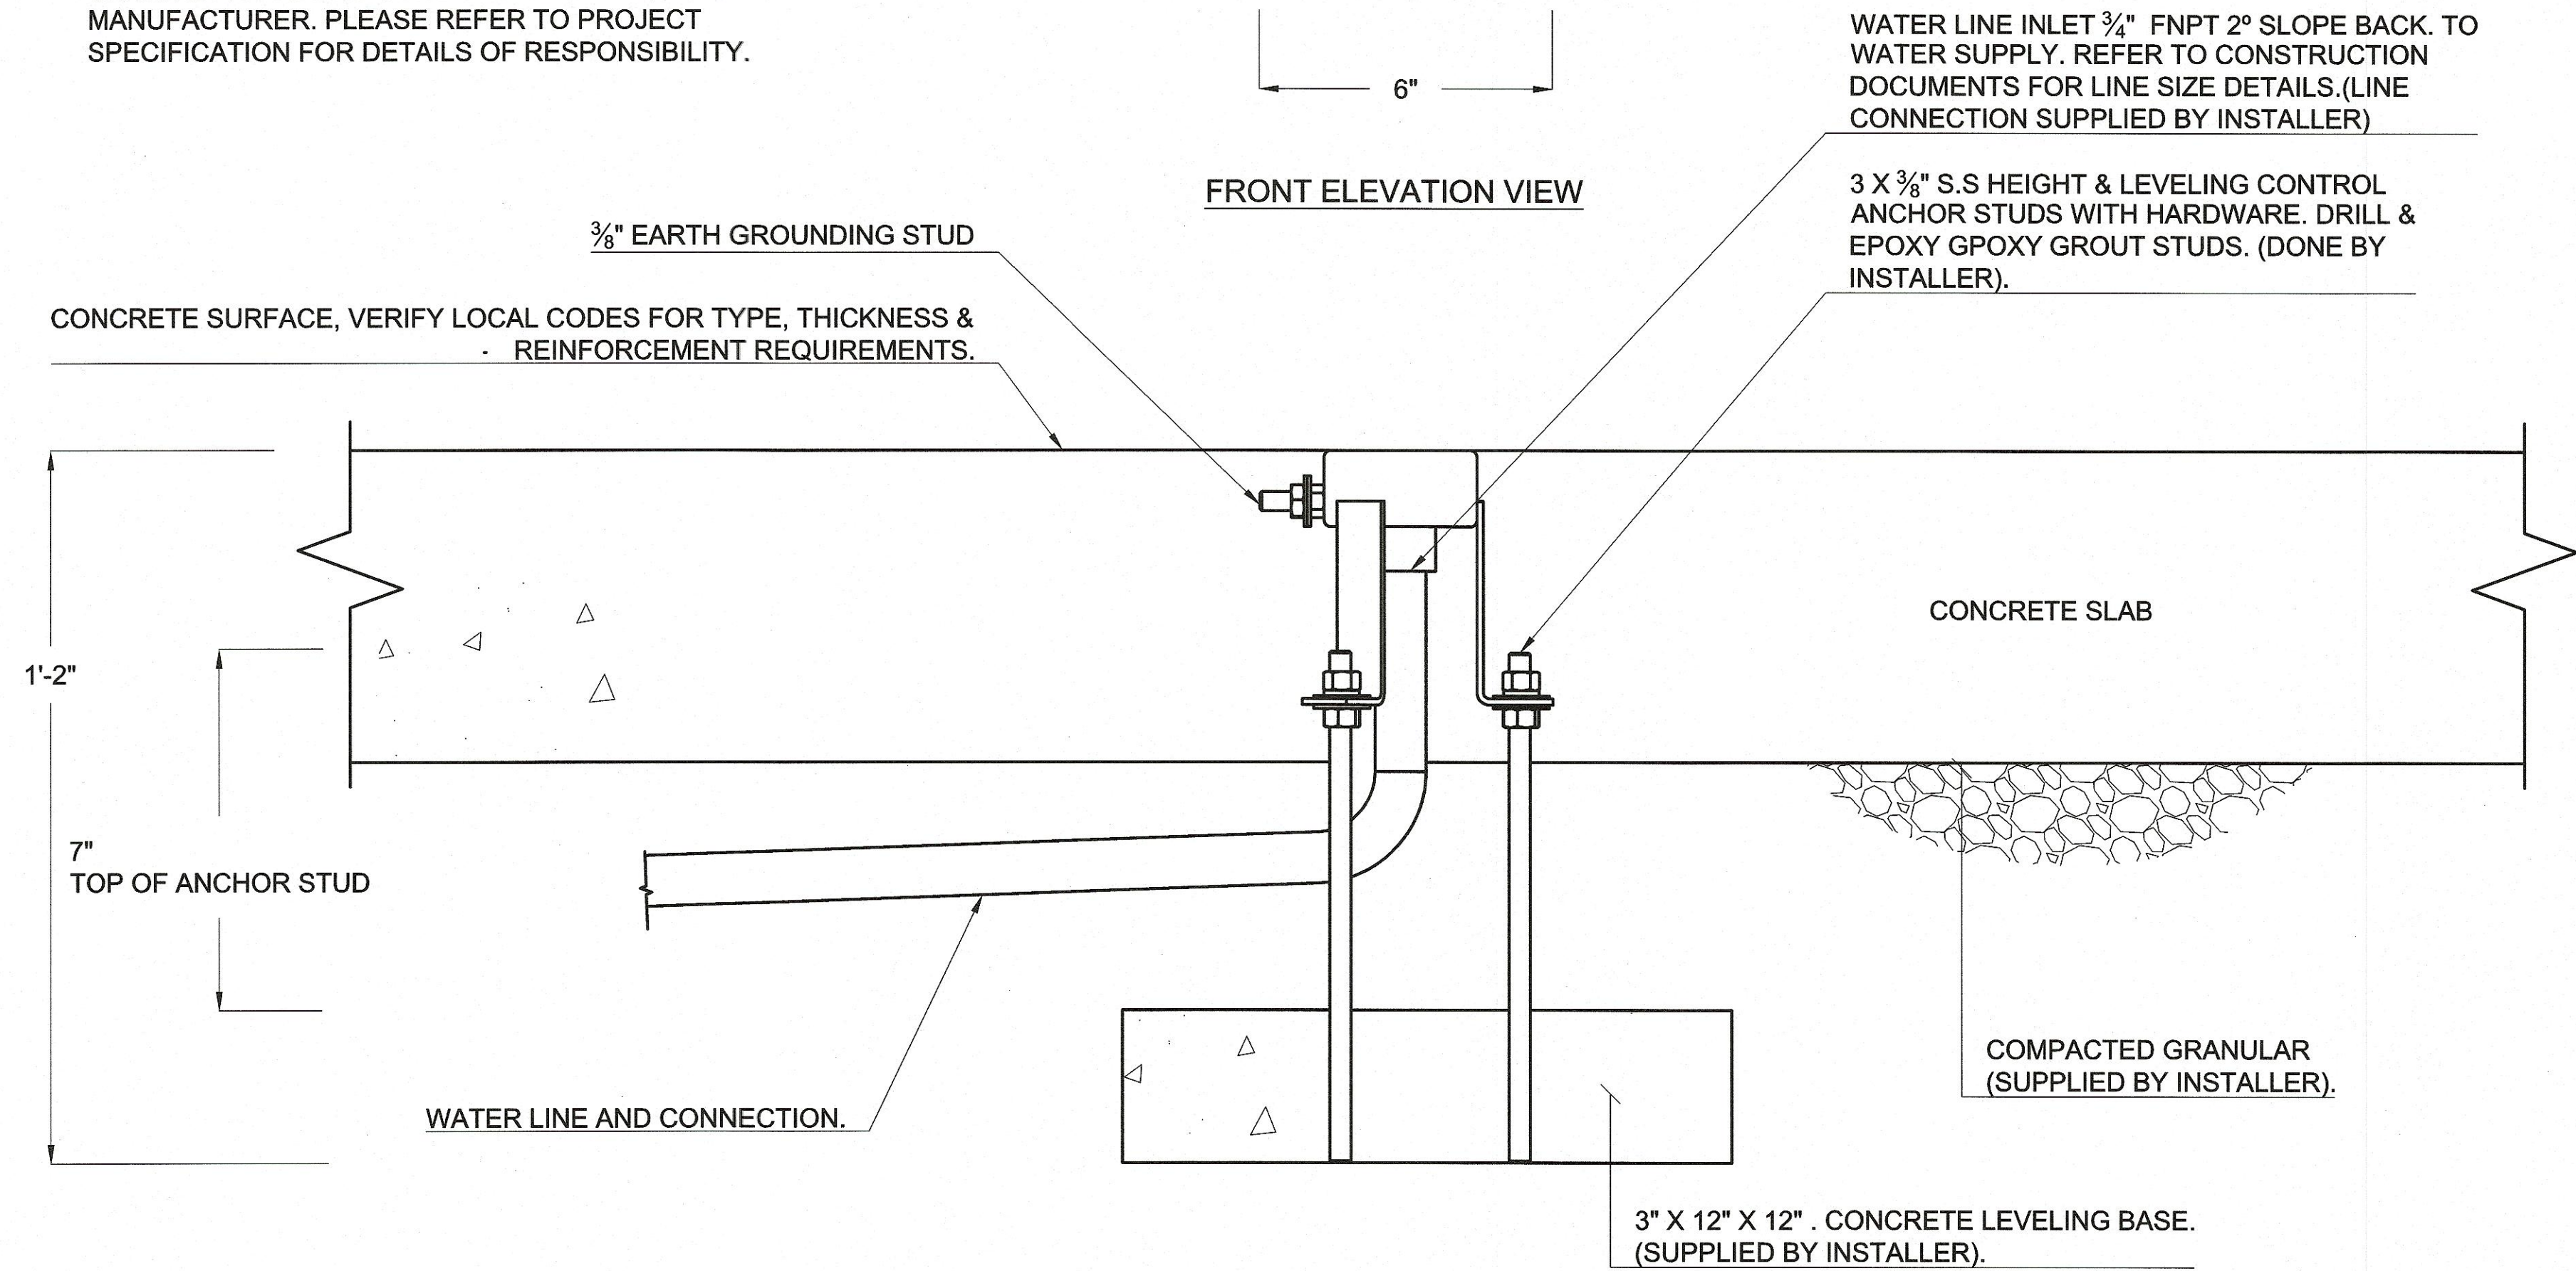

REV. NO.	DATE	DRWN	CHKD	REMARKS

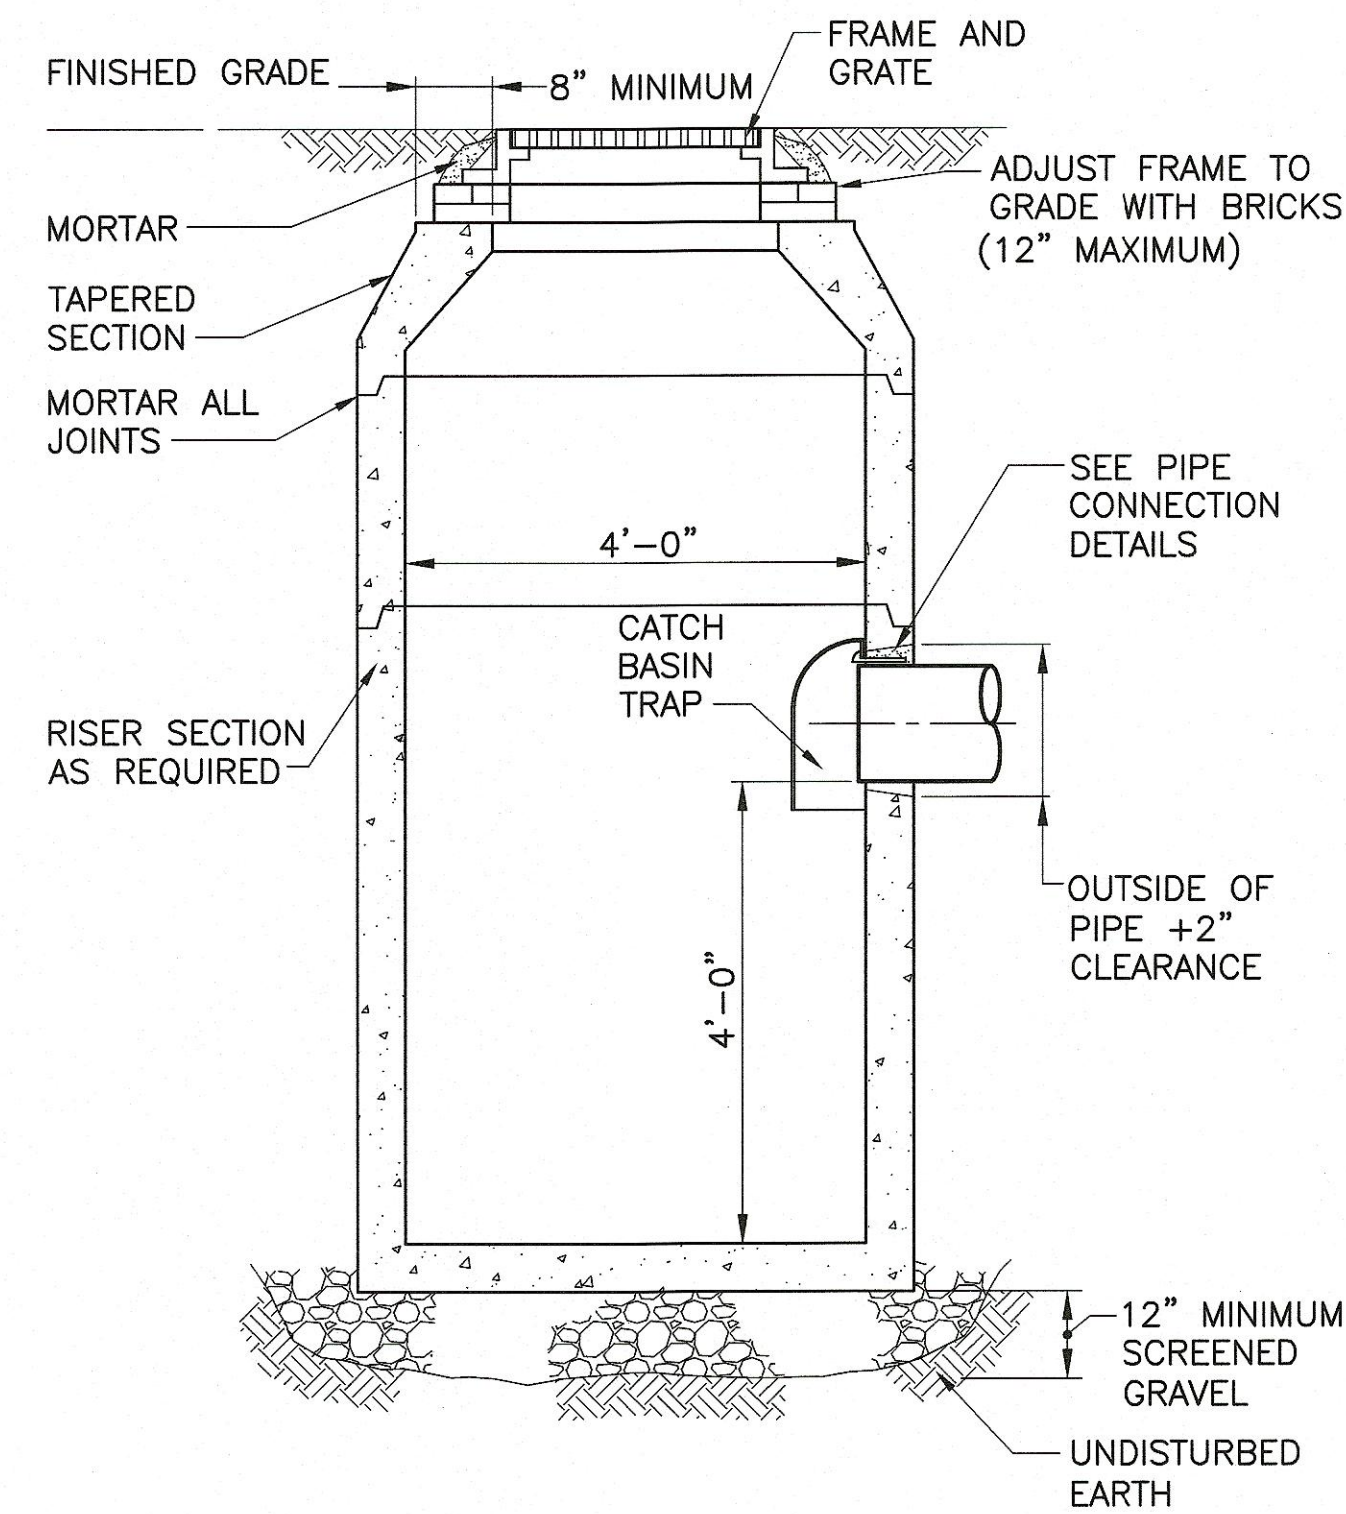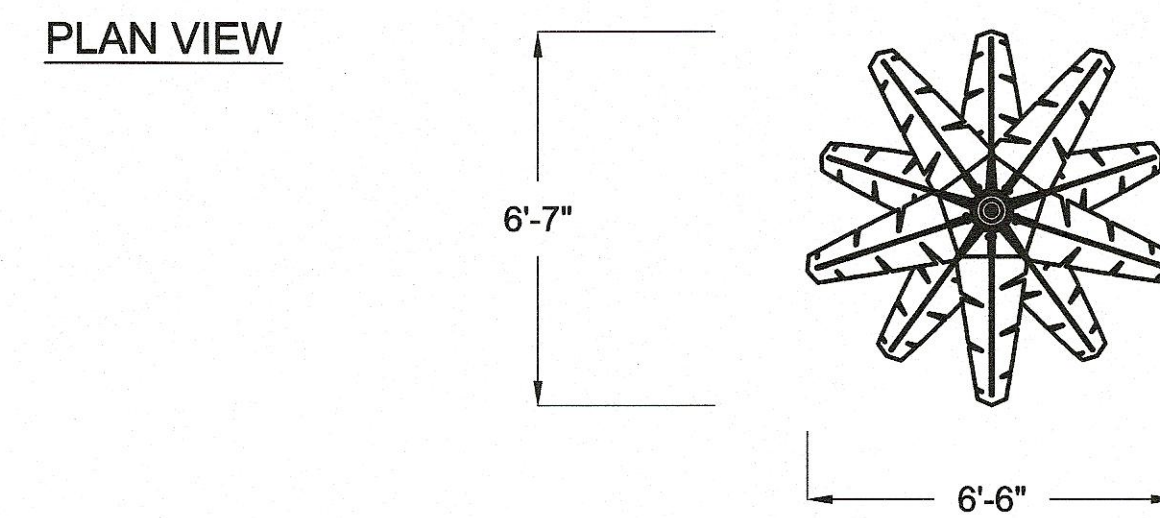DESIGNED BY: G. HOWARD
DRAWN BY: J. BRONENKANT
SHEET CHK'D BY: G. HOWARD
CROSS CHK'D BY: S. LANDGREN
APPROVED BY: S. LANDGREN
DATE: FEBRUARY 2023


CDM Smith
75 State Street
Boston, MA 02109
Tel: (617) 452-6000

CITY OF WATERTOWN, MA
FILIPPELLO PARK SPRAY PAD RENOVATION


SPRAY PAD DETAILS III

PROJECT NO. 56318-267753
FILE NAME: CD04STDT.dwg
SHEET NO.
D-4


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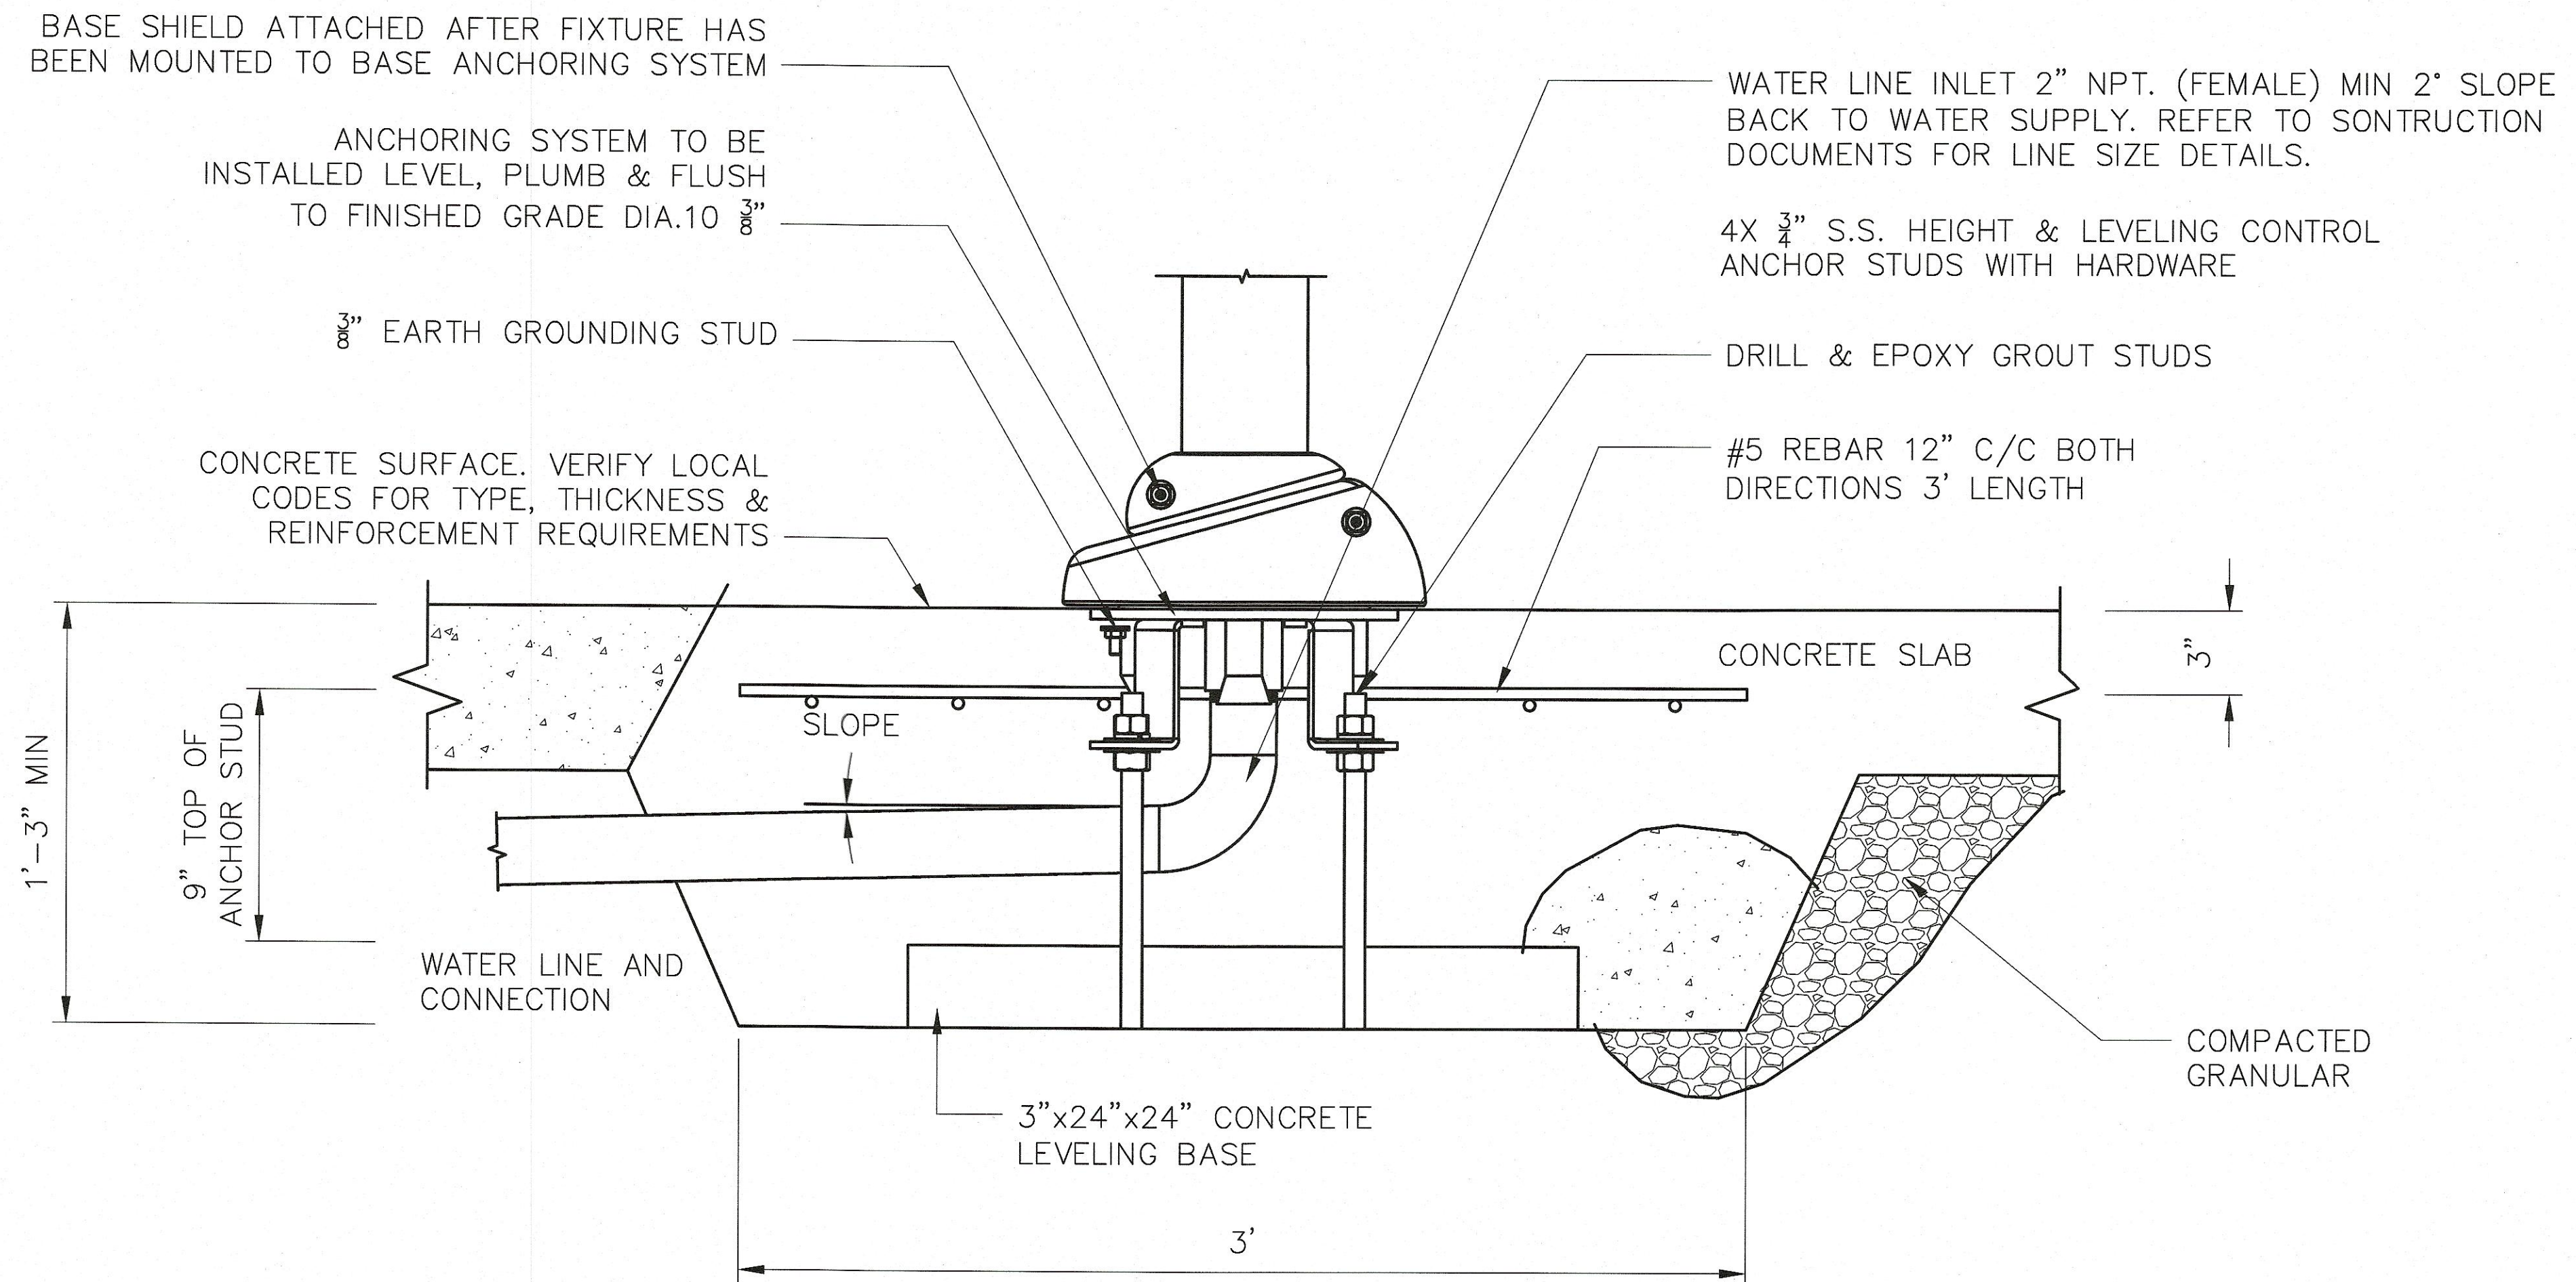
FRONT ELEVATION VIEW

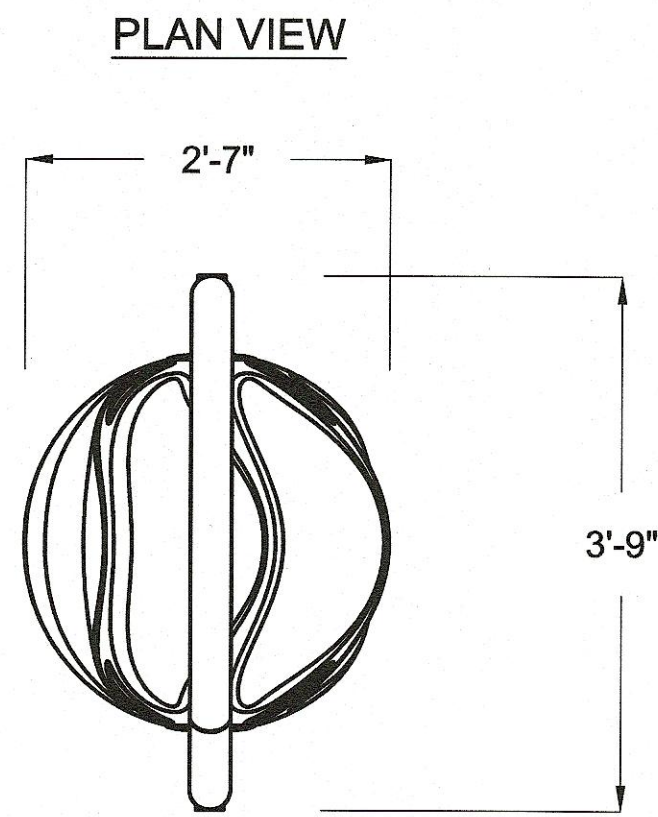


SIDE ELEVATION VIEW

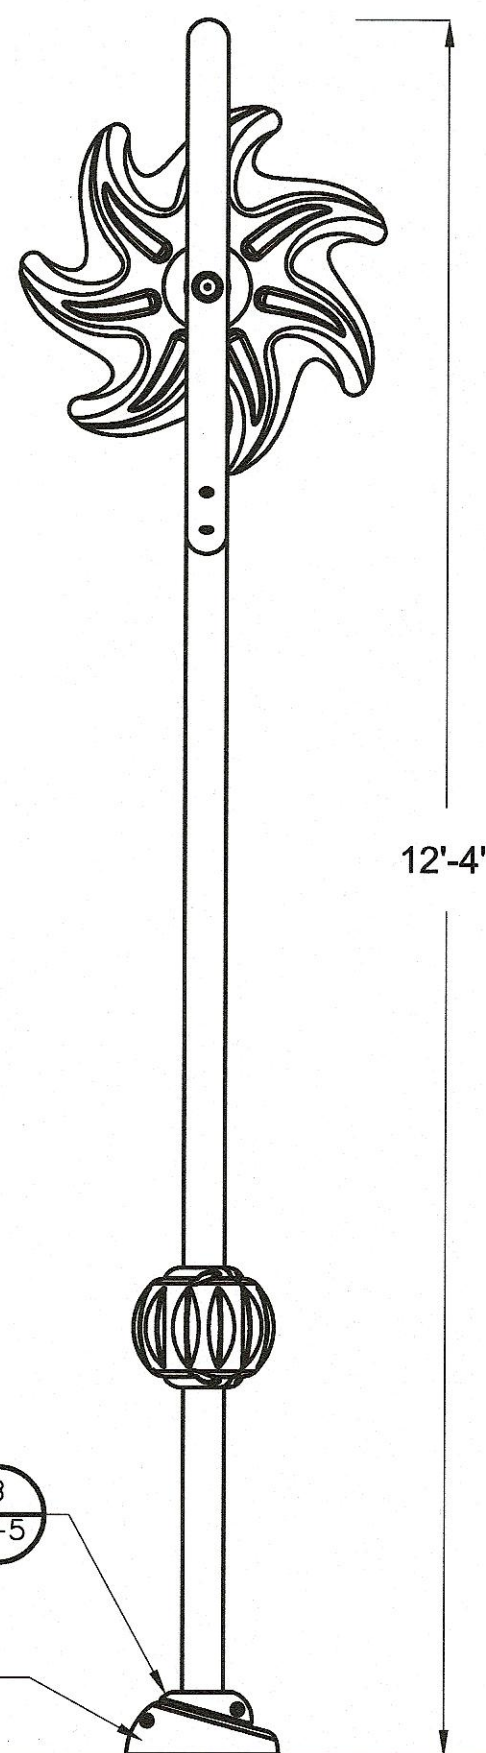


HELIO NO.6
DETAIL A
NOT TO SCALE

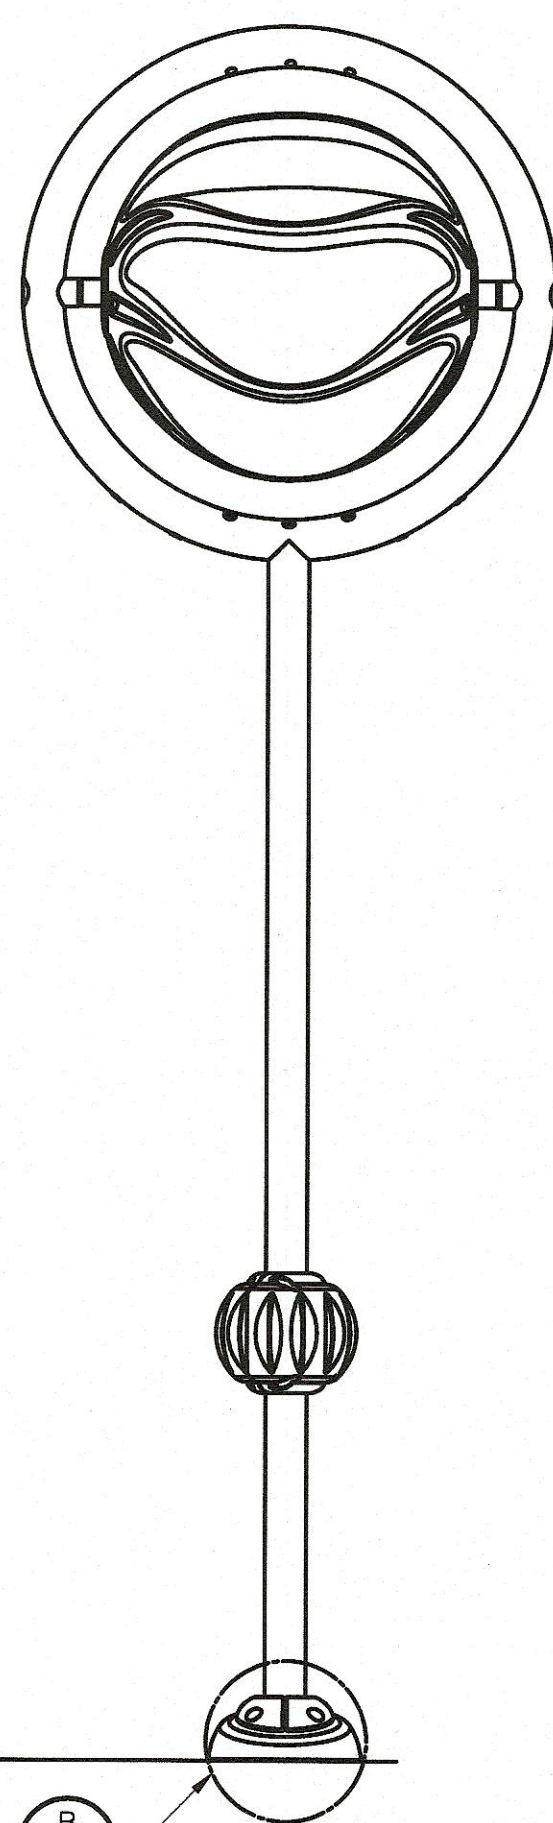

TYPICAL ANCHORING SYSTEM AND BASE SHIELD
DETAIL B
NOT TO SCALE

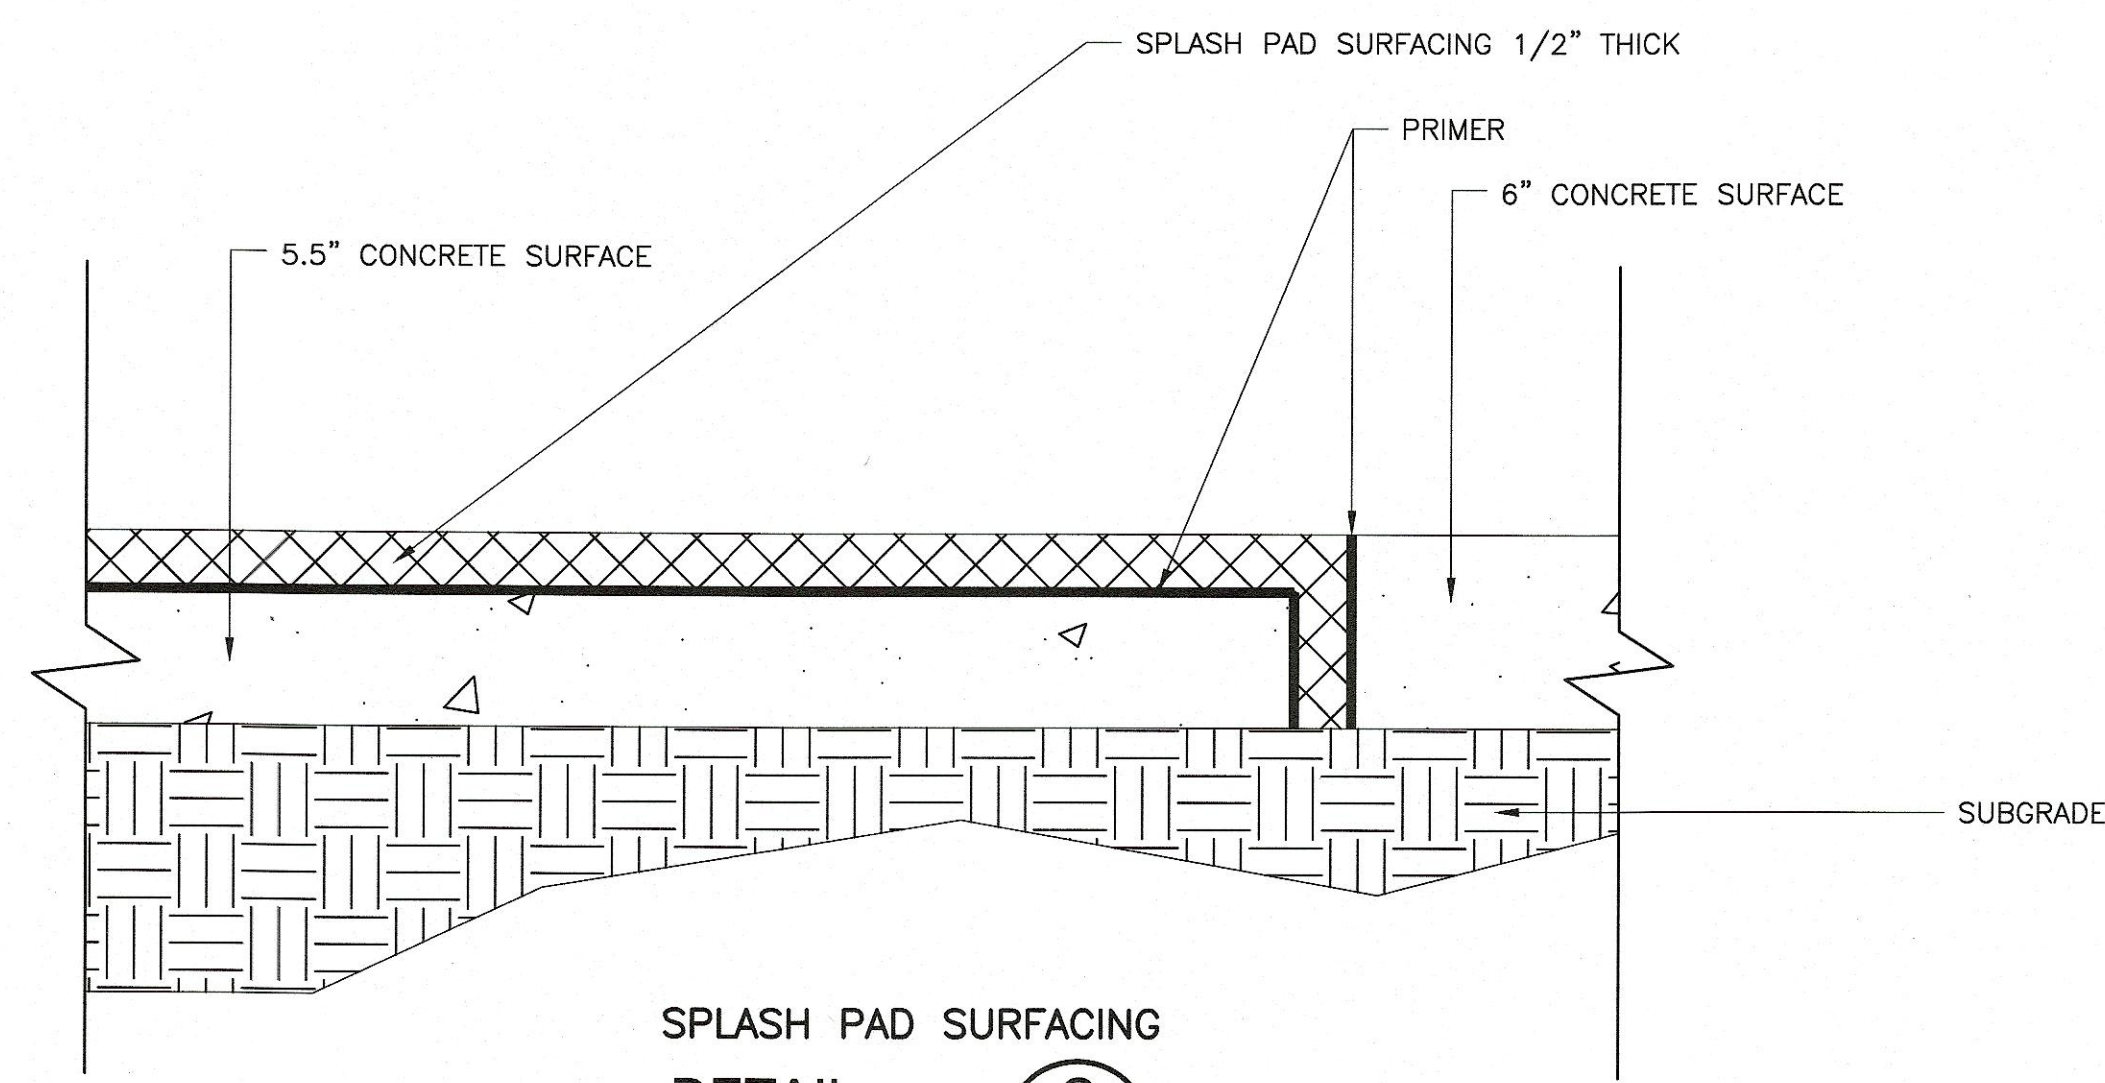

SPLASH PAD SURFACING
DETAIL C
NOT TO SCALE

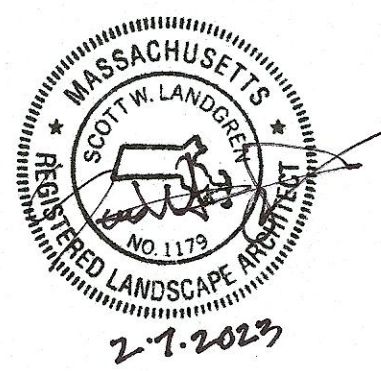

REV. NO.	DATE	DRWN	CHKD	REMARKS

DESIGNED BY: G. HOWARD	CDM Smith 75 State Street Boston, MA 02109 Tel: (617) 452-6000
DRAWN BY: J. BRONENKANT	
SHEET CHK'D BY: G. HOWARD	
CROSS CHK'D BY: S. LANDGREN	
APPROVED BY: S. LANDGREN	
DATE: FEBRUARY 2023	

CITY OF WATERTOWN, MA FILIPPELLO PARK SPRAY PAD RENOVATION	SPRAY PAD DETAILS IV	PROJECT NO. 56318-267753 FILE NAME: CD05STD.T.dwg
		SHEET NO.
		D-5

XREFs: [CDMS_2436] Images: []
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PW\\cdsmith--0202--pw.bentley.com:pw_btl\56318\267753\04 Design Services NL_60%09 Electrical\10 BIM_CADD\E001NFNT.dwg
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SCOPE OF WORK:

1. PROJECT PROVIDES SPRAY POOL UPGRADES AT FILIPPELLO PARK IN THE TOWN OF WATERTOWN, MA. MAJOR IMPROVEMENTS INCLUDE, BUT ARE NOT LIMITED TO, THE DEMOLITION OF THE EXISTING SPORTS SPRAY POOL SYSTEM AND THE INSTALLATION OF THE NEW SPRAY POOL SYSTEM AS SHOWN ON THE DRAWINGS AND AS SPECIFIED HEREIN.

GENERAL NOTES:

1. ELECTRICAL DRAWINGS ARE INTENDED TO SHOW THE GENERAL LAYOUT OF WORK TO BE INSTALLED UNDER THIS CONTRACT WITHOUT ATTEMPTING TO SHOW ALL DETAILS. FURNISH LABOR, MATERIALS, EQUIPMENT AND INCIDENTALS REQUIRED FOR A COMPLETE AND OPERATIONAL ELECTRICAL SYSTEM AS SHOWN ON THE CONTRACT DOCUMENTS.
2. COORDINATE WORK WITH OTHER TRADES AND THE OWNER.
3. MAINTAIN EXISTING PROCESS OPERATIONS. POWER INTERRUPTIONS TO ELECTRICAL EQUIPMENT SHALL BE AT OWNER'S CONVENIENCE WITH 72 HOURS MINIMUM NOTICE. EACH INTERRUPTION SHALL HAVE PRIOR WRITTEN APPROVAL.
4. FIELD VERIFY EXISTING UNDERGROUND ELECTRICAL CONDUIT, CONCRETE DUCT BANKS, MANHOLES, PULL BOXES, ETC. AND MECHANICAL PIPING. CONTRACTOR SHALL INCLUDE IN BID COSTS ASSOCIATED WITH RELOCATION OR REMOVAL OF UNDERGROUND EQUIPMENT AS REQUIRED BY THIS CONTRACT. USE DUE CARE IN CONGESTED AREAS TO AVOID DAMAGE TO EXISTING UNDERGROUND UTILITIES.
5. CONTRACTOR'S WORK SHALL INCLUDE COMPLETE TESTING OF EQUIPMENT AND WIRING INCLUDING MAKING MINOR CORRECTIONS, CHANGES, OR ADJUSTMENTS NECESSARY FOR THE PROPER FUNCTIONING OF THE SYSTEM AND EQUIPMENT. WORKMANSHIP SHALL BE OF THE HIGHEST QUALITY; SUBSTANDARD WORK WILL BE REJECTED.
6. DO NOT SCALE ELECTRICAL DRAWINGS. REFER TO MECHANICAL, STRUCTURAL DRAWINGS, AND APPROVED MANUFACTURER'S SHOP DRAWINGS FOR EXACT LOCATION OF EQUIPMENT. EXCEPT WHERE DIMENSIONS ARE SHOWN, LOCATIONS OF EQUIPMENT, FIXTURES, OUTLETS, AND SIMILAR DEVICES ARE APPROXIMATE.
7. WORK SHALL COMPLY WITH NEC AND LOCAL CODES.
8. DO NOT SPLICE CONDUCTORS EXCEPT AS NOTED.
9. POWER AND CONTROL CONDUITS SHALL HAVE AN EQUIPMENT GROUNDING CONDUCTOR WIRE SIZED PER TABLE 250.122 OF THE NEC UNLESS OTHERWISE NOTED.
10. COORDINATE SEQUENCE OF CONSTRUCTION WITH CIVIL, MECHANICAL, AND STRUCTURAL DISCIPLINES. PROVIDE TEMPORARY POWER AND CONTROL CIRCUITS AS REQUIRED TO MAINTAIN FACILITY OPERATION. VERIFY EXISTING UTILITIES IN AREA OF CONSTRUCTION. REFER TO CIVIL DRAWINGS FOR ADDITIONAL UNDERGROUND INFORMATION.
11. REPAIR, IN ACCORDANCE WITH SPECIFICATIONS, SIDEWALKS, WALLS, ROADWAYS, ETC. DISTURBED BY CONSTRUCTION ACTIVITIES WHETHER OR NOT SHOWN FOR REPAIR/REPAVING ON CIVIL DRAWINGS.
12. CONCEAL CONDUITS TO GREATEST EXTENT PRACTICABLE. CONDUITS RUN AT EXISTING STRUCTURES SHALL BE RUN EXPOSED.
13. WHERE LOCAL DISCONNECTS AND CONTROL PANELS ARE SHOWN ON PLAN VIEWS, LOCATIONS ARE APPROXIMATE. ADJUST LOCATION AS REQUIRED TO COMPLY WITH NEC ARTICLE 110 FOR WORKING CLEARANCES.
14. DO NOT INSTALL MAJOR CONDUIT RUNS THROUGH AREAS DESIGNATED FOR FUTURE STRUCTURES.

SUBMITTALS:

1. SUBMIT SHOP DRAWINGS FOR EQUIPMENT, MATERIALS AND OTHER ITEMS FURNISHED UNDER DIVISION 26.
2. SUBMIT CONDUIT SHOP DRAWINGS FOR YARD ELECTRICAL, WITHIN AND UNDER ROADS, BUILDINGS AND STRUCTURES PRIOR TO COMMENCING WORK. DO NOT POUR CONCRETE UNTIL ENGINEER HAS APPROVED THE ASSOCIATED SHOP DRAWING.
3. SUBMIT OPERATION AND MAINTENANCE MANUALS FOR EQUIPMENT FURNISHED UNDER DIVISION 26.
4. SUBMIT STARTUP/COMMISSIONING PLANS FOR EQUIPMENT FURNISHED UNDER DIVISION 26.
5. SUBMIT TESTING AND SERVICE REPORTS FOR EQUIPMENT AND MATERIALS FURNISHED UNDER DIVISION 26.
6. SUBMIT TRAINING PLANS FOR EQUIPMENT FURNISHED UNDER DIVISION 26.
7. SUBMIT RECORD DOCUMENTATION TO ACCURATELY SHOW COMPLETED INSTALLATION. INCLUDE MODIFICATIONS TO CONTRACT DOCUMENTS (ONE LINE POWER DIAGRAMS, EQUIPMENT ELEVATIONS, PANEL SCHEDULES, ELEMENTARY CONTROL DIAGRAMS, RISER DIAGRAMS, PLANS, CONDUIT AND DUCTBANK ROUTING, ETC) ALONG WITH ADDITIONAL DRAWINGS OR SKETCHES CREATED TO CONVEY COMPLETED INSTALLATION.

INTERPRETATION OF CONTRACT DOCUMENTS:

1. IF DURING PERFORMANCE OF WORK, THERE IS A CONFLICT, ERROR, OR DISCREPANCY BETWEEN OR AMONG CONTRACT DOCUMENTS AND LAWS AND REGULATIONS, PROVIDE THE HIGHER PERFORMANCE STANDARD UNLESS OTHERWISE DIRECTED BY ENGINEER.
2. PRIORITY OF DOCUMENTS: FIGURED DIMENSIONS GOVERN OVER SCALED DIMENSIONS, DETAILED DRAWINGS GOVERN OVER GENERAL DRAWINGS, LARGER SCALE DRAWINGS TAKE PRECEDENCE OVER SMALLER SCALE DRAWINGS, CHANGE ORDER DRAWINGS SUPERCEDE ORIGINAL CONTRACT DRAWINGS, AND CONTRACT DRAWINGS GOVERN SHOP DRAWINGS.
3. IN GENERAL, DRAWINGS DO NOT SHOW CONDUIT ROUTING. PLAN AND ROUTE CONDUITS IN COMPLIANCE WITH SPECIFICATIONS AND DRAWING DETAILS. COORDINATE INSTALLATION WITH OTHER TRADES AND ACTUAL SUPPLIED EQUIPMENT.
4. DUCTBANK ROUTING SHOWN ON ELECTRICAL SITE PLANS IS DIAGRAMMATIC IN NATURE AND MAY NOT INCLUDE INTERFERENCES THAT MAY BE PRESENT.
5. SEE ADDITIONAL NOTES ON ELECTRICAL LEGEND SHEET.

ENCLOSURE TYPES:

PROVIDE THE FOLLOWING NEMA TYPE ELECTRICAL ENCLOSURES, UNLESS OTHERWISE NOTED:

1. NEMA 1 IN DRY, NON-PROCESS INDOOR LOCATIONS.
2. NEMA 12 IN "DUST" LOCATIONS SHOWN ON THE DRAWINGS.
3. NEMA 4X IN OUTDOOR LOCATIONS, ROOMS BELOW GRADE INCLUDING BASEMENTS AND BURIED VAULTS AND "DAMP" OR "WET" LOCATIONS SHOWN ON THE DRAWINGS.

MATERIALS AND EQUIPMENT:

1. PROVIDE NEW MATERIALS AND EQUIPMENT UNLESS SPECIFICALLY NOTED OTHERWISE.
2. ELECTRICAL EQUIPMENT AND MATERIALS SHALL BE LISTED BY UNDERWRITER'S LABORATORIES, INC., AND SHALL BEAR APPROPRIATE UL LISTING MARK OR CLASSIFICATION MARKING. EQUIPMENT, MATERIALS, ETC. UTILIZED NOT BEARING A UL CERTIFICATION SHALL BE FIELD OR FACTORY UL CERTIFIED PRIOR TO EQUIPMENT ACCEPTANCE AND USE.
3. PROVIDE MAJOR ELECTRICAL EQUIPMENT BY A SINGLE MANUFACTURER: I.E. UNIT SUBSTATIONS, SWITCHGEAR, MOTOR CONTROL CENTERS, DISCONNECT SWITCHES, TRANSFORMERS, PANELBOARDS, ETC.

EQUIPMENT SIZE, HANDLING AND STORAGE:

1. COORDINATE WITH EQUIPMENT MANUFACTURER SHIPPING SPLITS TO PERMIT SAFE HANDLING AND PASSAGE OF EQUIPMENT TO FINAL INSTALLATION LOCATION.
2. COMPLY WITH MANUFACTURER'S INSTRUCTIONS FOR UPRIGHT EQUIPMENT ORIENTATION DURING TRANSPORTATION.
3. PROTECT EQUIPMENT FROM MECHANICAL INJURY, OR EXPOSURE TO MOISTURE, CHEMICALS, OR CORROSIVE GASES. DO NOT STORE ELECTRICAL EQUIPMENT OUTDOORS.
4. PROVIDE AND ENERGIZE TEMPORARY SPACE HEATERS IF REQUIRED TO CONTROL MOISTURE DURING STORAGE.

CUTTING AND PATCHING:

1. CUT AND PATCH IN A WORKMANLIKE MANNER AS REQUIRED TO INSTALL ELECTRICAL WORK.
2. CUTTING OF STRUCTURAL MEMBERS SUCH AS JOISTS, BEAMS, GIRDERS OR COLUMNS IS PROHIBITED.
3. PATCH SURFACES TO RESTORE TO ORIGINAL INTEGRITY (WATERPROOF OR FIREPROOF AS REQUIRED) AND APPEARANCE.

DEMOLITION AND DISPOSITION OF EQUIPMENT:

1. DRAWING PLANS SHOWING REMOVAL OF MAJOR MECHANICAL AND ELECTRICAL EQUIPMENT IS NOT INTENDED TO SHOW ALL COMPONENTS TO BE DEMOLISHED. NOT ALL PIPING, CONDUITS, DUCTS, EQUIPMENT, ANCILLARY DEVICES, ETC. ARE SHOWN. THE CONTRACTOR IS TO FIELD VERIFY EXISTING CONDITIONS PRIOR TO BID.
2. UNLESS OTHERWISE SPECIFICALLY NOTED, REMOVE UNUSED EXPOSED CONDUIT AND SUPPORT SYSTEMS BACK TO SOURCE AND/OR POINT OF CONCEALMENT INCLUDING ABOVE ACCESSIBLE CEILING FINISHES. WIRING SHALL BE REMOVED.
3. CUT FLUSH WITH SLAB, CEILING, OR WALL ABANDONED CONCEALED CONDUIT. SUITABLY PLUG CONDUITS.
4. REPAIR AND RESTORE ADJACENT CONSTRUCTION AND FINISHES AFTER DEMOLITION IS COMPLETE.
5. MATERIAL AND EQUIPMENT INDICATED FOR REMOVAL OR DEMOLITION IS TO BECOME CONTRACTOR'S PROPERTY UPON REMOVAL, UNLESS NOTED OTHERWISE. REMOVED MATERIAL TO BE PROPERLY HANDLED AND DISPOSED.

CLEANING:


1. REMOVE ALL RUBBISH AND DEBRIS FROM INSIDE AND AROUND ELECTRICAL EQUIPMENT AND ENCLOSURES.
2. REMOVE DIRT, DUST OR CONCRETE SPATTER FROM INTERIOR AND EXTERIOR OF EQUIPMENT USING BRUSHES, VACUUM CLEANER OR CLEAN LINT-FREE RAGS. DO NOT USE COMPRESSED AIR.

DELEGATED DESIGN / PROFESSIONAL ENGINEERING SERVICES:

1. WHEN ENGINEERING SERVICES ARE SPECIFIED TO BE PROVIDED BY CONTRACTOR, CONTRACTOR SHALL RETAIN A LICENSED PROFESSIONAL ENGINEER TO PERFORM THE SERVICES. ENGINEER SHALL BE LICENSED AT THE TIME SERVICES ARE PERFORMED AND LICENSED IN THE STATE IN WHICH PROJECT IS LOCATED. IF THE STATE ISSUES DISCIPLINE SPECIFIC LICENSES, ENGINEER SHALL BE LICENSED IN THE APPLICABLE DISCIPLINE. ENGINEER SHALL BE EXPERIENCED IN THE TYPE OF WORK BEING PERFORMED.
2. ENGINEERING WORK SHALL BE DONE ACCORDING TO THE APPLICABLE REGULATIONS FOR PROFESSIONAL ENGINEERS TO INCLUDE SIGNING, SEALING AND DATING DOCUMENTS.

NEC CLASSIFIED HAZARDOUS AREAS:

1. THIS PROJECT INCLUDES NEC CLASSIFIED HAZARDOUS AREA. THE FOLLOWING NATIONAL FIRE PROTECTION ASSOCIATION (NFPA) STANDARDS APPLY:
- 1.1. NFPA 820 – STANDARD FOR FIRE PROTECTION IN WASTEWATER TREATMENT AND COLLECTION FACILITIES.
2. REFER TO SHEET E-3 FOR ADDITIONAL INFORMATION ON CLASSIFICATION BOUNDARIES.
3. EQUIPMENT, MATERIALS, AND INSTALLATION SHALL COMPLY WITH NEC ARTICLES 500, 501, 502, AND 503.

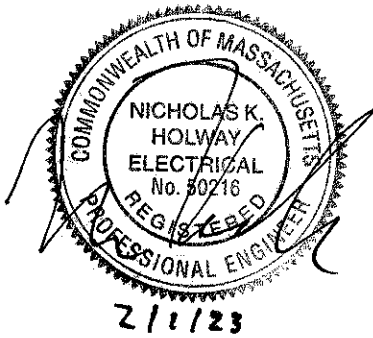

REV.	NO.	DATE	DRWN	CHKD	REMARKS

DESIGNED BY:	C. CASTEEL
DRAWN BY:	C. CASTEEL
SHEET CHK'D BY:	J. SANCHEZ
CROSS CHK'D BY:	G. HOWARD
APPROVED BY:	N. HOLWAY
DATE:	FEBRUARY 2023

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75 State Street
Boston, MA 02109
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CITY OF WATERTOWN, MA	PROJECT NO. 56318-267753 FILE NAME: E001NFNT.DWG
FILIPPELLO PARK SPRAY PAD RENOVATION	SHEET NO. E-1
ELECTRICAL GENERAL NOTES	

REV. NO.	DATE	DRWN	CHKD	REMARKS

DESIGNED BY: C. CASTEEL
 DRAWN BY: C. CASTEEL
 SHEET CHK'D BY: J. SANCHEZ
 CROSS CHK'D BY: G. HOWARD
 APPROVED BY: N. HOLWAY
 DATE: FEBRUARY 2023

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CITY OF WATERTOWN, MA

FILIPPELLO PARK SPRAY PAD RENOVATION

...VN, MA ...PAD RENOVATION	ELECTRICAL LEGEND
--------------------------------	-------------------

MCC1-1: 1) 2) 3°C., 3#3/0, 1#2G DENOTES A QUANTITY OF TWO (2) 3-INCH CONDUITS EACH CONTAINING THREE NO. 3/0 AWG CONDUCTORS AND 1 NO. 2 AWG GROUND CONDUCTOR, FROM NEMA SIZE 6 STARTER IN MCC-1 TO 250HP MOTOR LOAD.


MCC1-1A: 3/4"C., 7#14, 1#14G DENOTES ONE 3/4-INCH CONDUIT CONTAINING SEVEN NO. 14 AWG CONTROL CONDUCTORS AND 1 NO. 14 AWG GROUND CONDUCTOR.

MCC1-1 AND MCC1-1A: DENOTES CONDUIT IDENTIFICATION (ID) (TYPICAL)

NOTES:


1. PROTECTIVE/CONTROL DEVICE AS SHOWN.
2. CONTROL/AUXILIARY DEVICES AT OR NEAR EQUIPMENT. EQUIPMENT SHALL BE INSTALLED AND WIRED AS REQUIRED BY EQUIPMENT FURNISHED AND/OR CONTROL DIAGRAM.

- GENERAL NOTE
THIS IS A STANDARD LEGEND.
SOME SYMBOLS MAY NOT
APPEAR ON THE DRAWINGS.

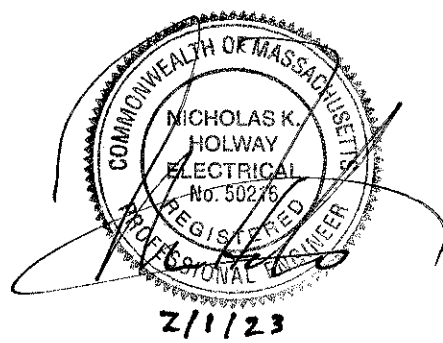


XREFs: [CDMS_2436, Working Plan, CEP000ST, Vortex, Layout] Images: []

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pw\\cdmsmith-c202-pwbenley.com\\pw-pl1\\56318\\267753\\04 Design Services NW_60x\\09 Electrical\\10 BIN\\CADD\\E003STPL.dwg
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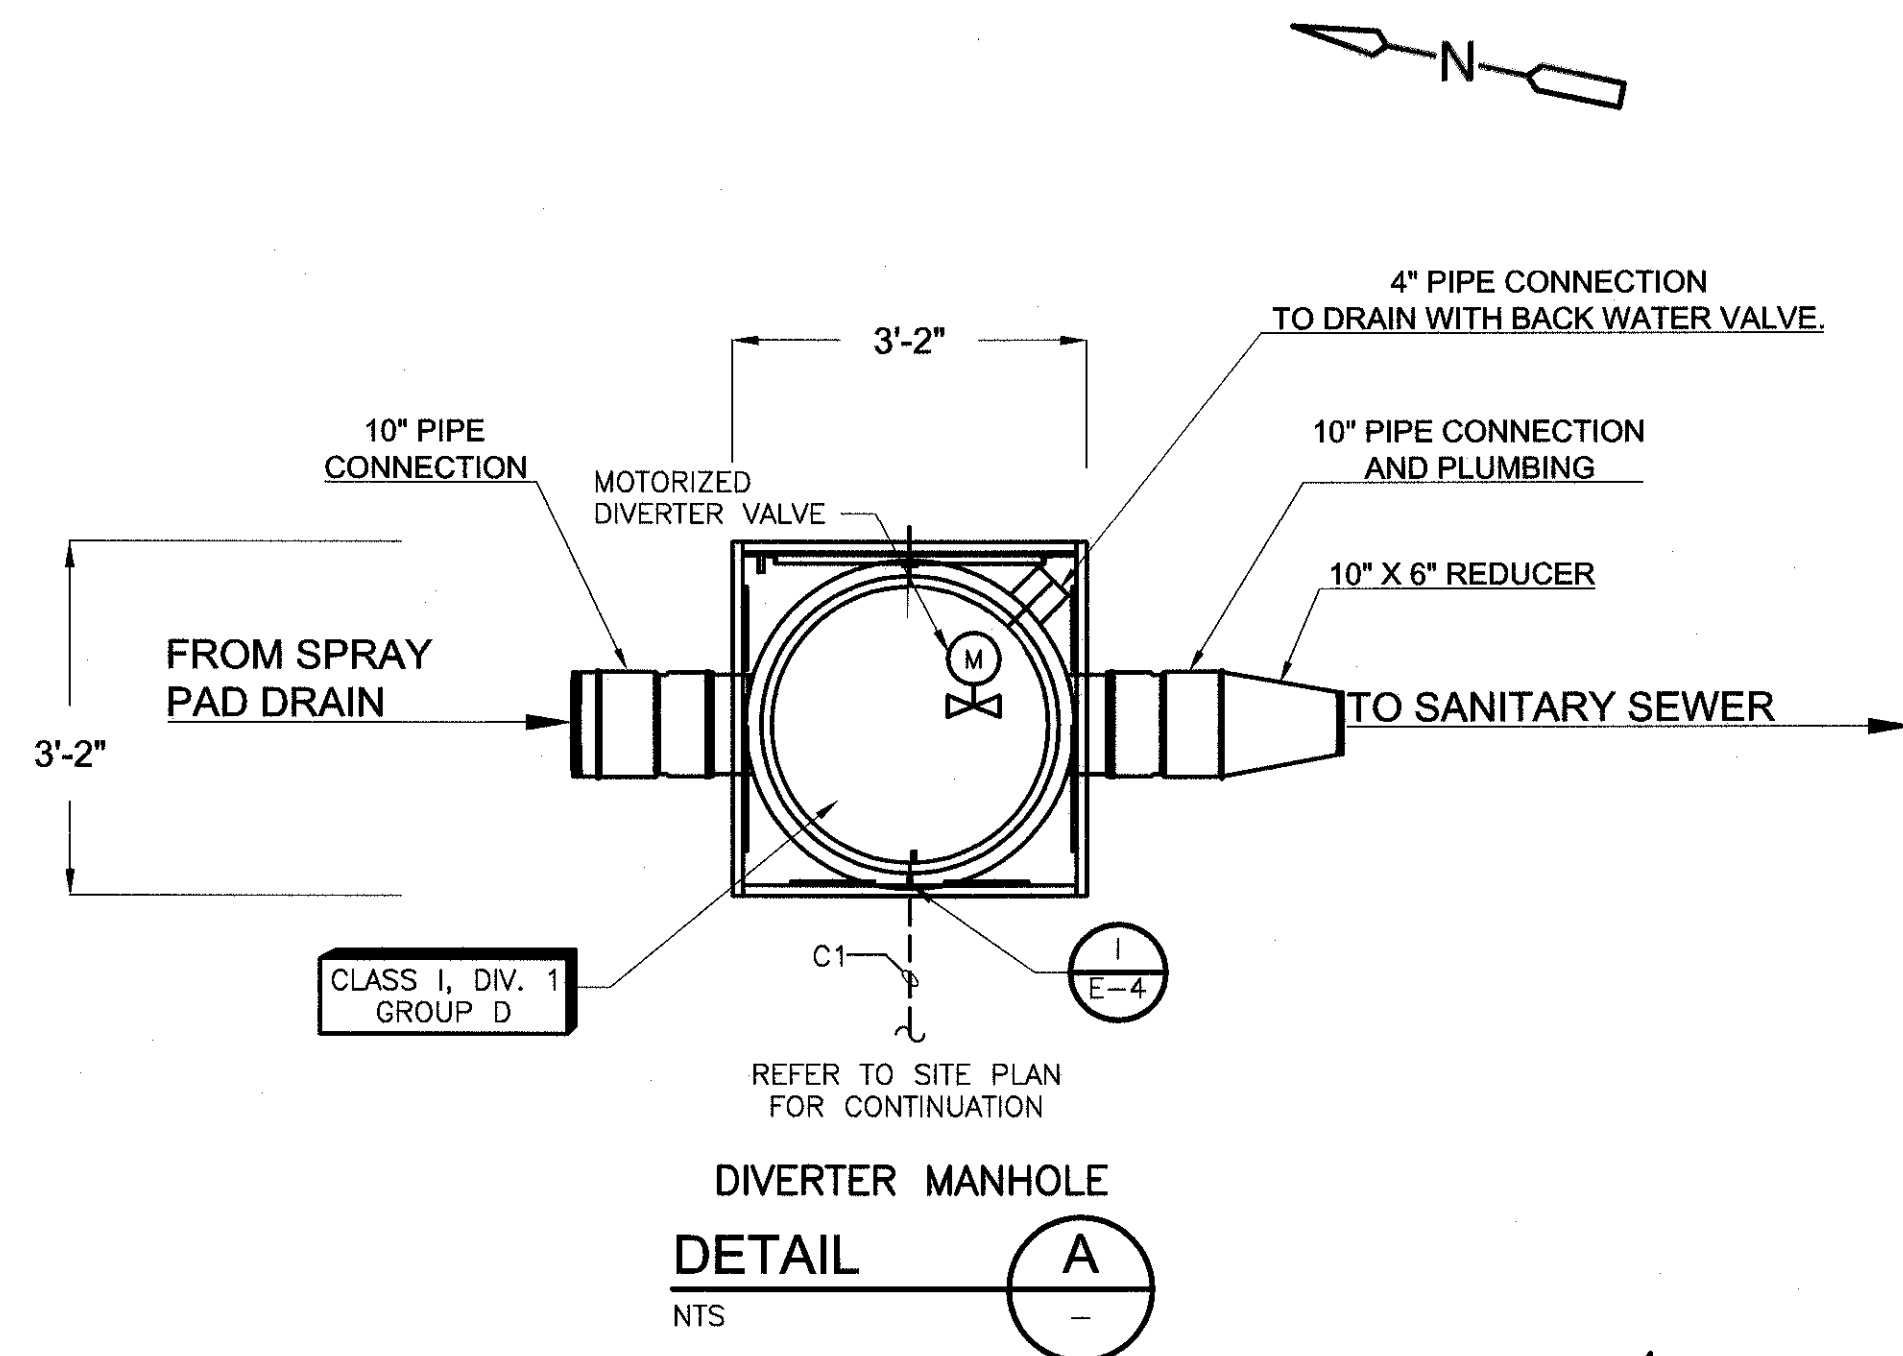
EXISTING RESTROOM BUILDING ENLARGED DEMOLITION

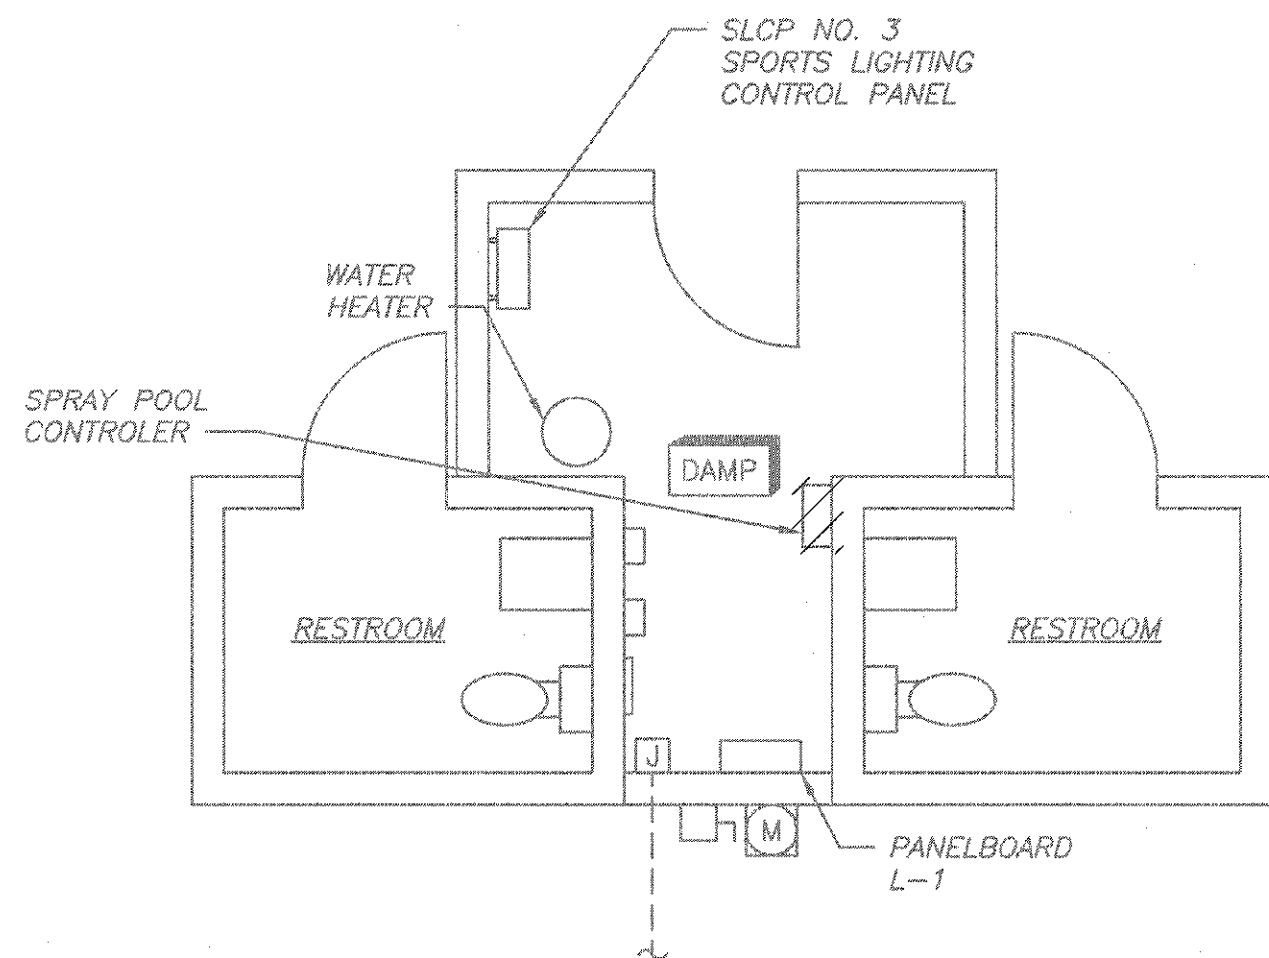PLAN
1/4" = 1'-0"
1/4" = 1'-0"
2 1 0 2 4



EXISTING RESTROOM BUILDING ENLARGED MODIFICATIONS

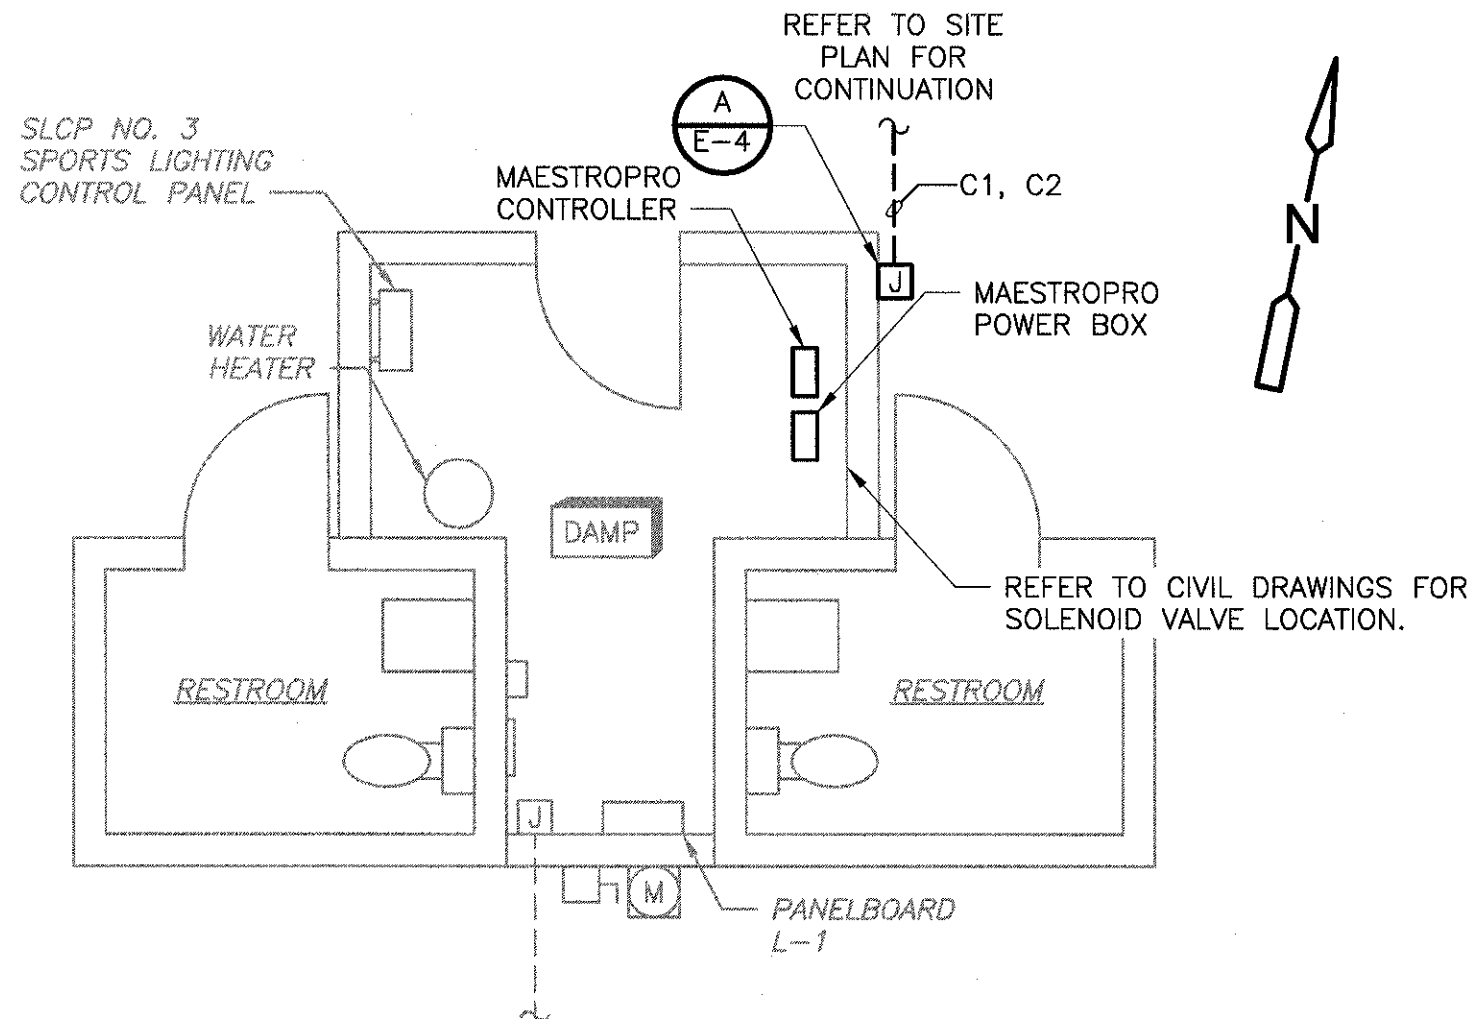PLAN
1/4" = 1'-0"
1/4" = 1'-0"
2 1 0 2 4



DIVERTER MANHOLE
DETAIL
NTS

NOTES:


1. CONDUIT ROUTING IS SHOWN DIAGRAMMATICALLY. NOT ALL CONDUITS ARE SHOWN FOR CLARITY.
2. ALL UNDERGROUND CONDUITS ARE DIRECT BURIED UNLESS OTHERWISE NOTED.
3. ALL ELECTRICAL EQUIPMENT AND DEVICES SHOWN ARE PROPOSED LOCATIONS ONLY. FINAL EQUIPMENT LOCATIONS SHALL BE DETERMINED BY THE CONTRACTOR AND SHALL MEET NATIONAL ELECTRIC CODE NFPA 70 REQUIREMENTS IN ITS ENTIRETY AND ANY STATE AND LOCAL CODES THAT MAY APPLY. ELECTRICAL EQUIPMENT LOCATIONS SHALL ALSO MEET NEC CODE "ARTICLE 110 REQUIREMENTS FOR ELECTRICAL INSTALLATIONS." CONTRACTOR SHALL SUBMIT PROPOSED EQUIPMENT AND DEVICE LOCATIONS SHOWING CONDUIT/WIRING FOR APPROVAL BY THE ENGINEER.
4. EXPANSION FITTINGS SHALL BE INSTALLED WHERE CONDUITS LEAVE THE EARTH AND ENTER THE ENCLOSURE.
5. EXTERIOR BARE COPPER GROUNDING ELECTRODE CONDUCTOR SHALL BE #4/0 BURIED 30" BELOW FINISHED GRADE AND A MINIMUM OF 36" FROM BUILDING/EQUIPMENT.
6. ALL BURIED EXTERIOR GROUND CONNECTIONS SHALL BE EXOTHERMIC WELD TYPE.
7. GROUNDS EXPOSED MORE THAN 6" SHALL BE INSTALLED IN CONDUIT.
8. EXOTHERMIC WELD #4/0 BARE COPPER GROUND TO FOOTING REBAR, WITHIN OR NEAR THE BOTTOM OF THE FOOTING THAT IS IN DIRECT CONTACT WITH EARTH.
9. BOND ALL METAL WATER PIPING ENTERING THE BUILDING INCLUDING POTABLE WATER, SEWAGE, AND PROCESS SYSTEMS TO GROUND GRID. SIZE BONDING CONDUCTOR PER NEC ARTICLE 250/14.

KEYED NOTES:

- 1 REFER TO PANELBOARD SCHEDULE FOR CONDUIT AND CONDUCTOR REQUIREMENTS.
- 2 RELOCATE EXISTING UNDERGROUND RACEWAYS TO ALLOW FOR INSTALLATION OF THE DIVERTER VALVE STRUCTURE.
- 3 BOND FEATURE TO GROUND ROD USING #8 BARE COPPER BONDING WIRE.


SPLASH PAD INSTALLATION NOTES:

1. WIRING FROM THE SPRAY POOL CONTROLLER TO EACH ACTIVATOR SHALL BE #22 AWG. A TOTAL OF FIVE (5) CONDUCTORS PER ACTIVATOR. CABLE LENGTH UP TO 246-FT PROVIDED BY VENDOR.
2. ALL CONNECTIONS TO THE CONTROLLER AND OTHER VENDOR ELECTRICAL PANEL SHALL BE PERFORMED USING AN APPROVED NEMA 4X CONNECTOR.
3. MAESTROPRO CONTROLLER SHALL BE POWERED THROUGH MAESTROPRO POWER BOX.

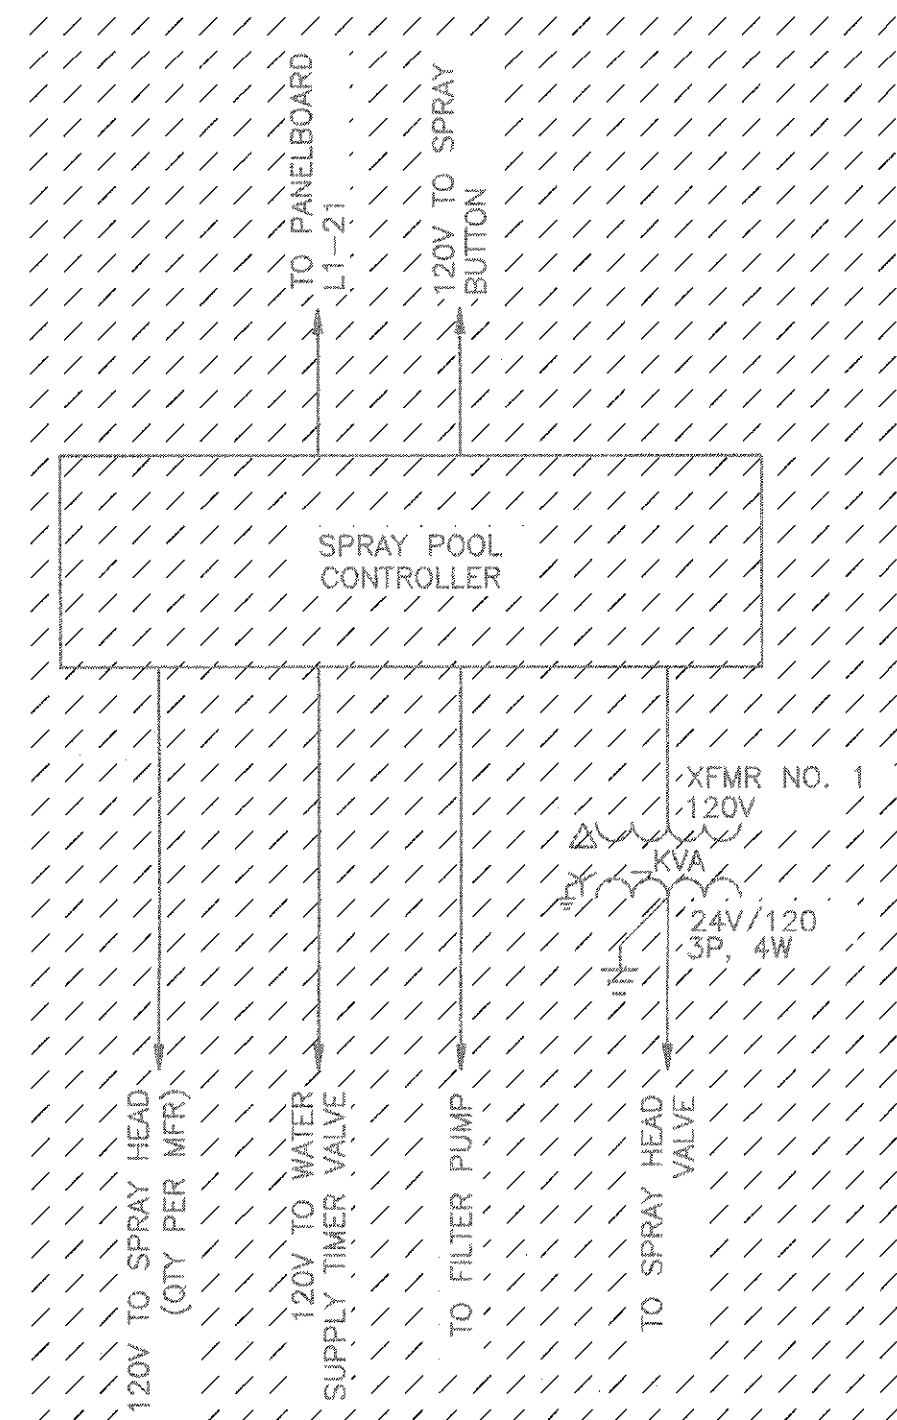


EXISTING CONTROLLER DEMOLITION

DIAGRAM
NTS

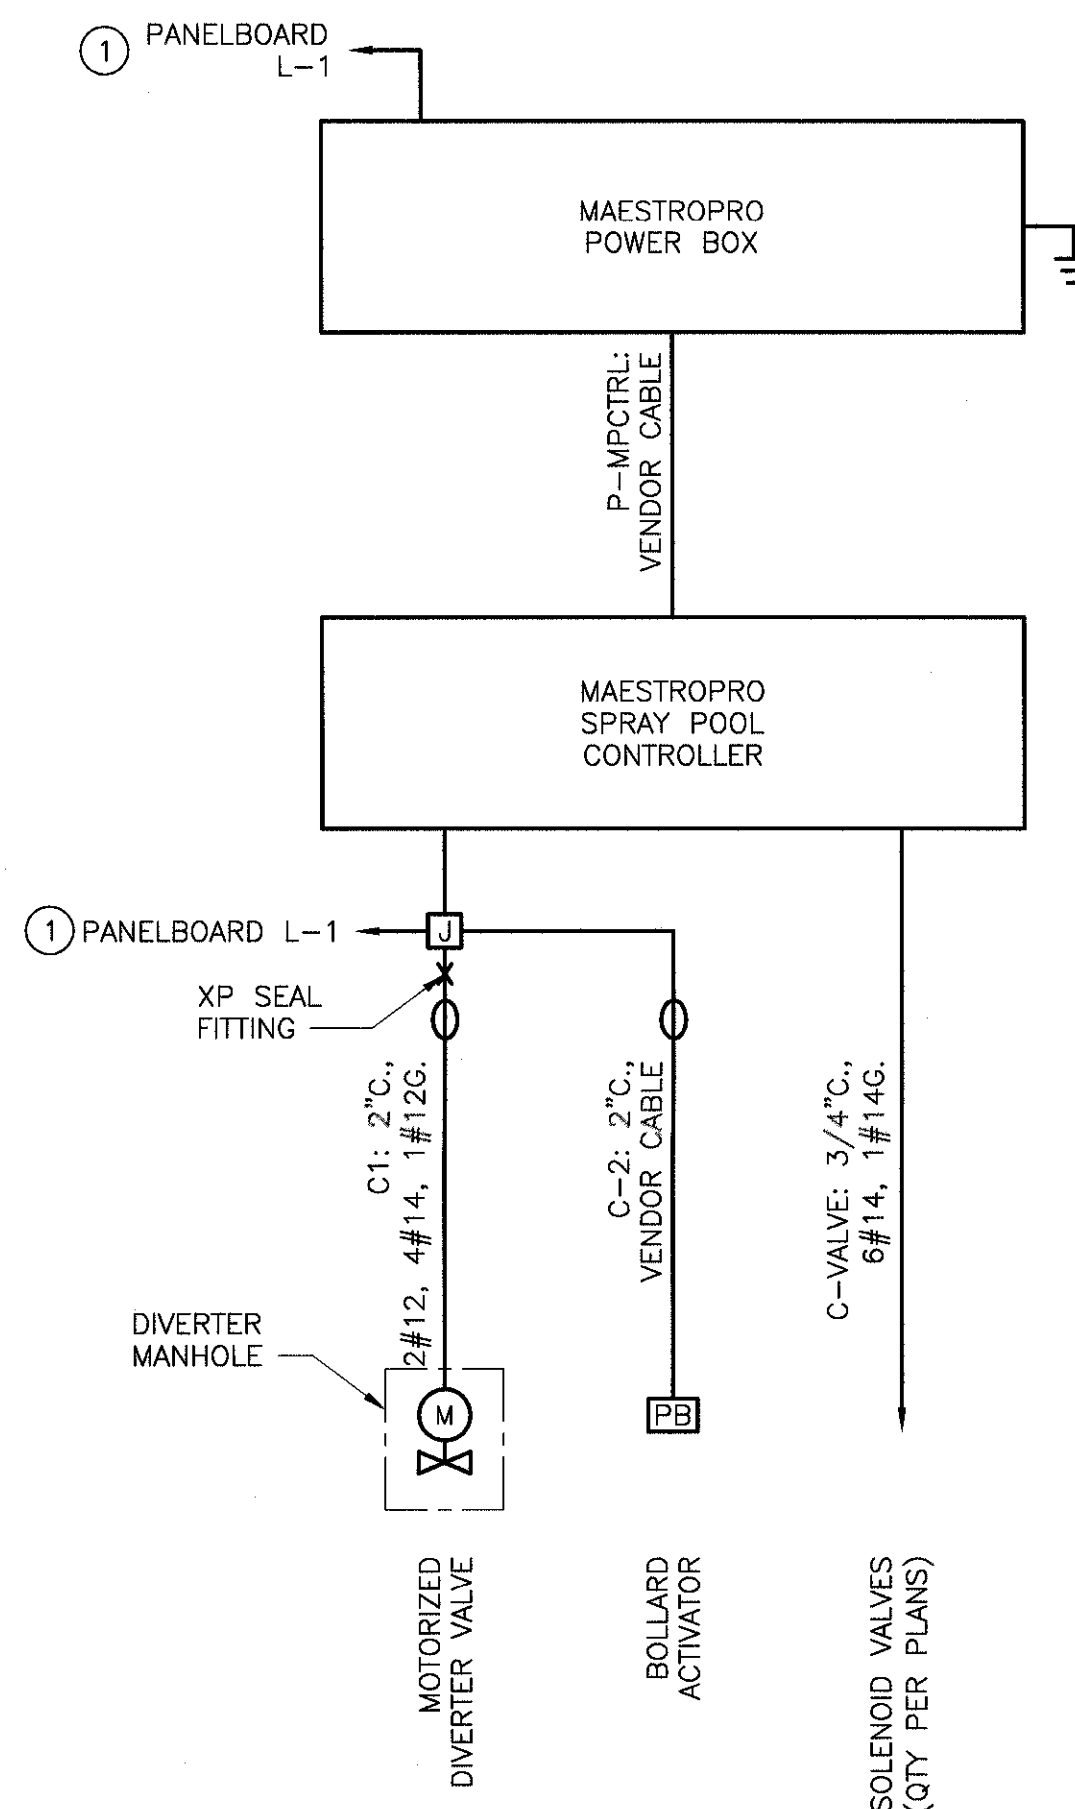

SPRAY PAD CONTROLLER RISER


DIAGRAM
NTS

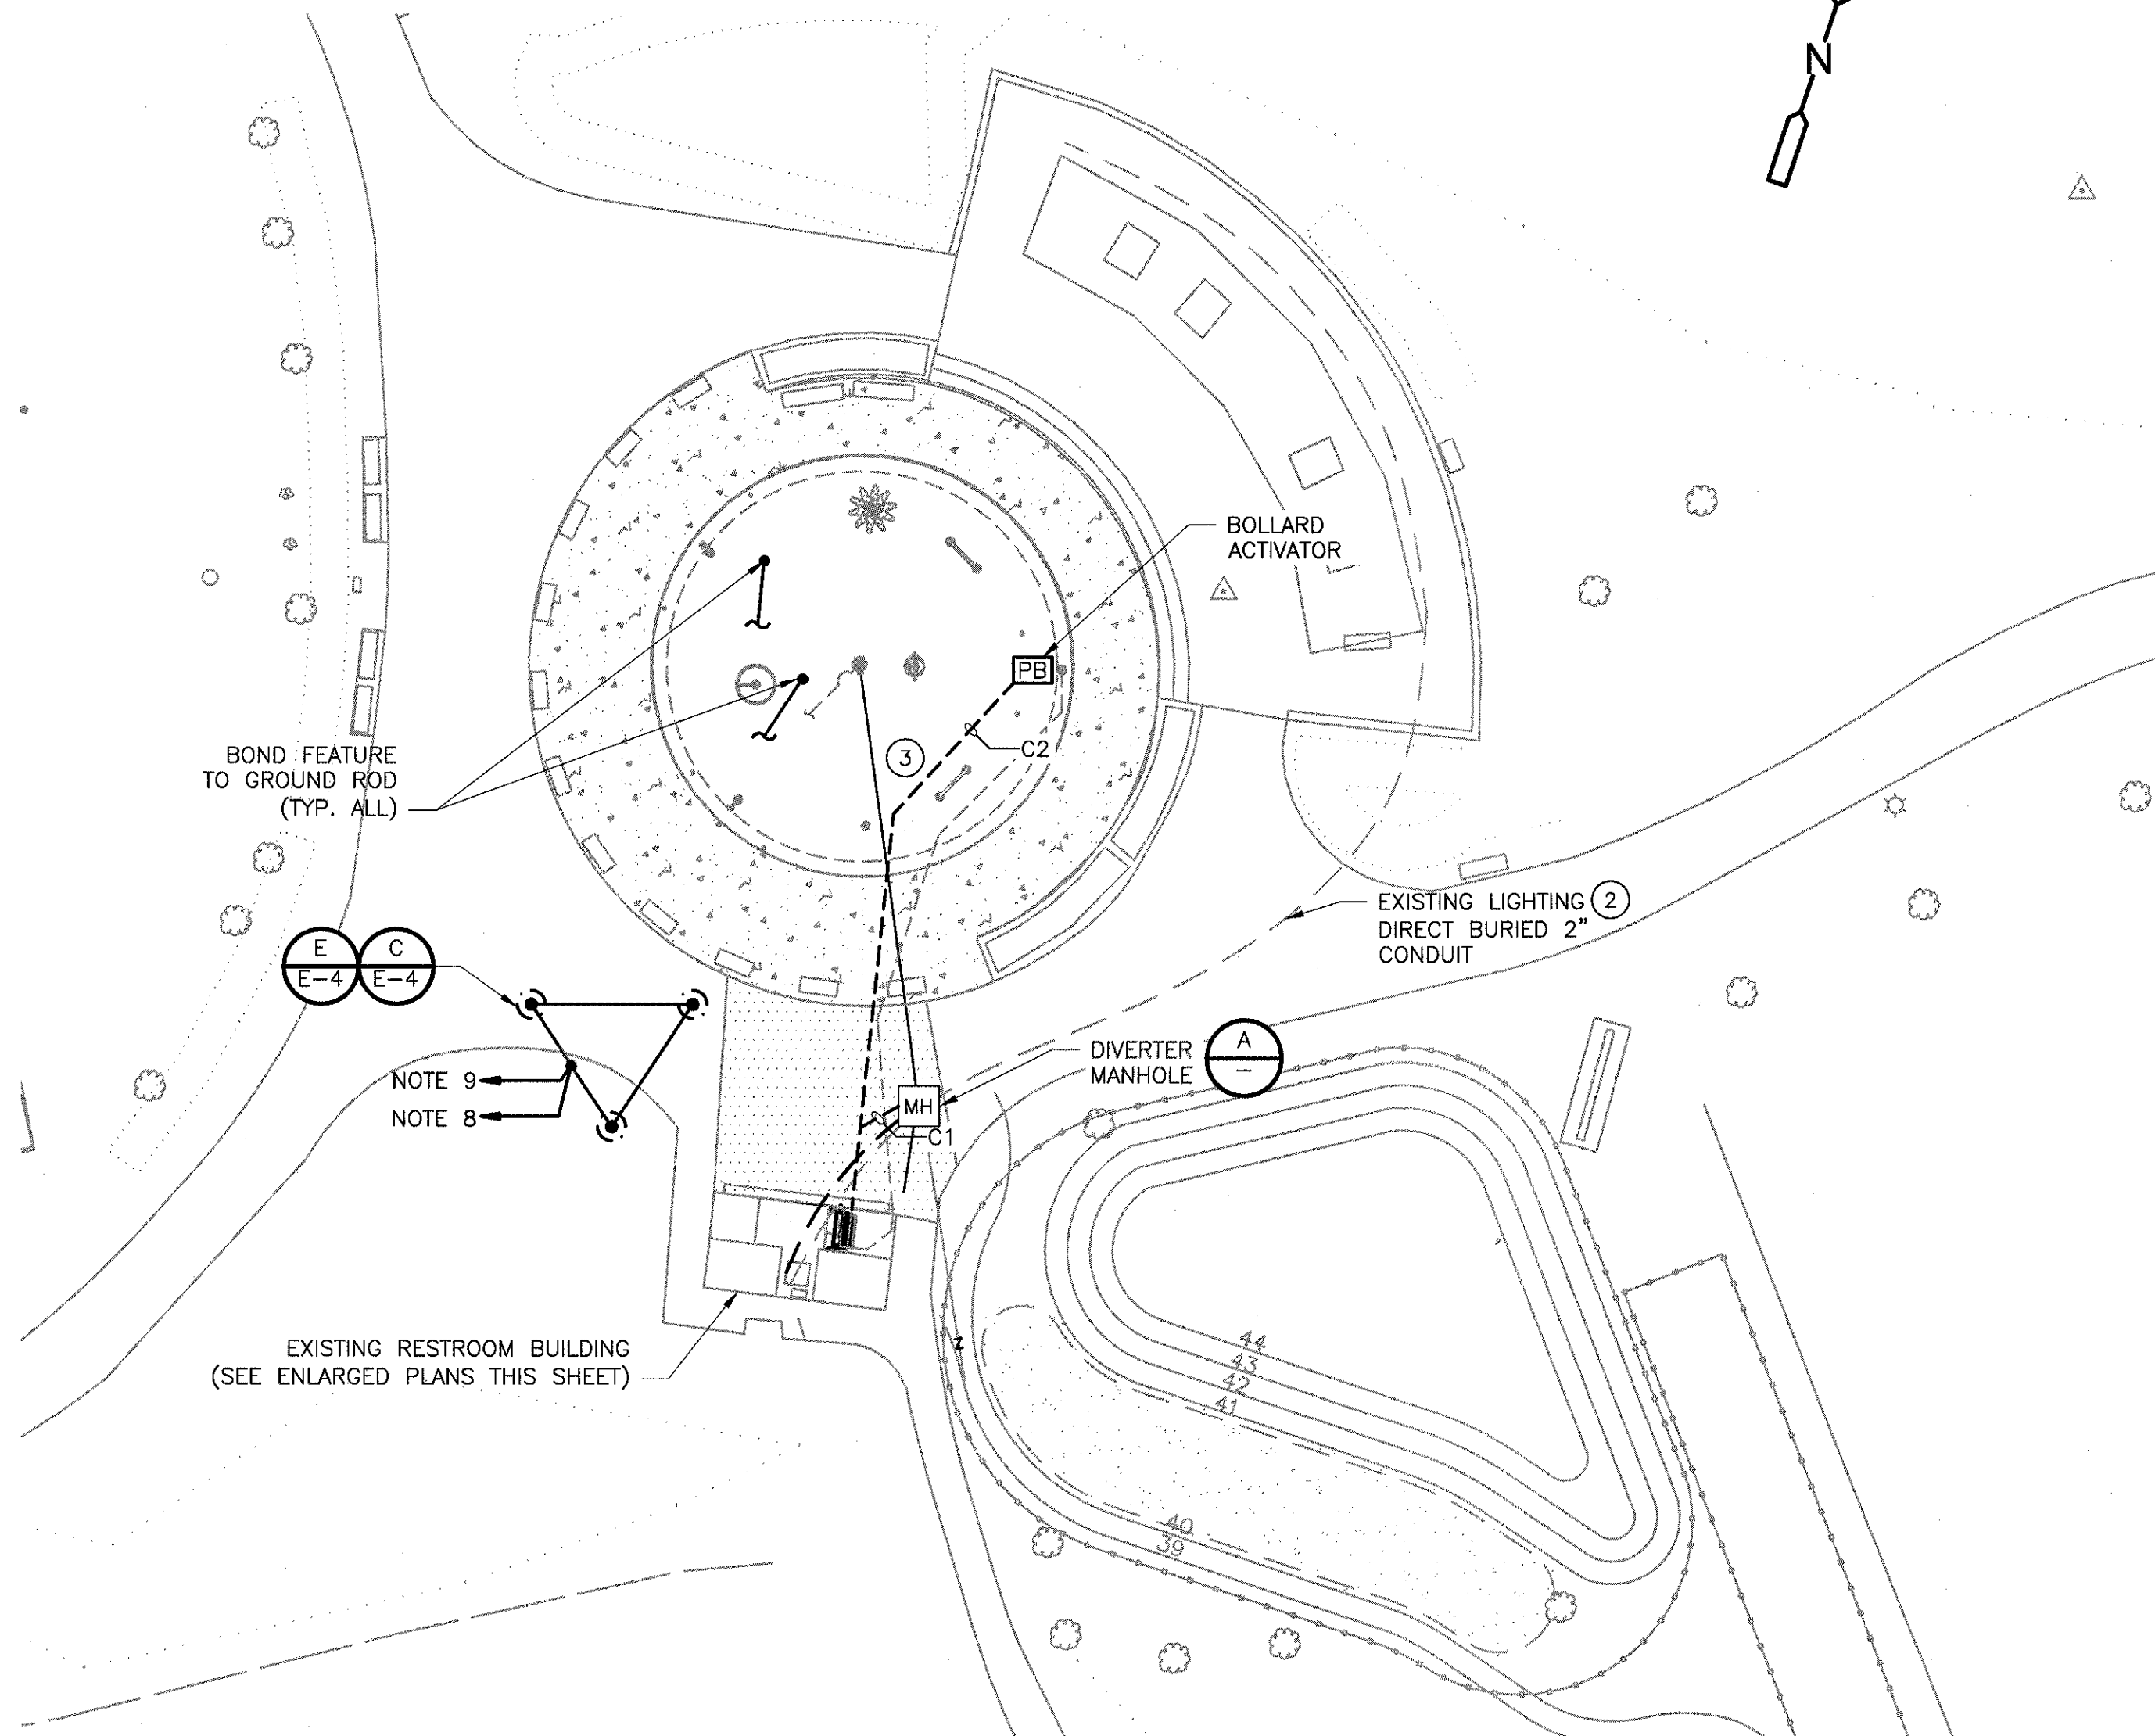

ELECTRICAL SITE

PLAN

1" = 20'
1" = 20'
10 0 20

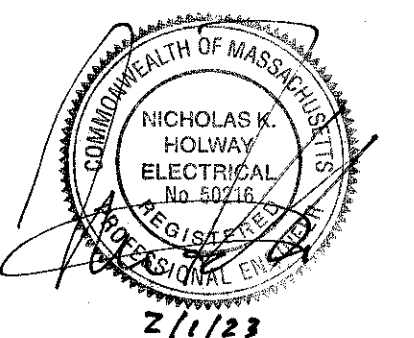

REV. NO.	DATE	DRWN	CHKD	REMARKS

DESIGNED BY: C. CASTELL
DRAWN BY: C. CASTELL
SHEET CHK'D BY: J. SANCHEZ
CROSS CHK'D BY: G. HOWARD
APPROVED BY: N. HOLWAY
DATE: FEBRUARY 2023

CDM Smith
75 State Street
Boston, MA 02109
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CITY OF WATERTOWN, MA

FILIPPELLO PARK SPRAY PAD RENOVATION

ELECTRICAL PLANS
& RISER DIAGRAMS

PROJECT NO. 56318-267753

FILE NAME: E003STPL.DWG

SHEET NO.

E-3

E-4